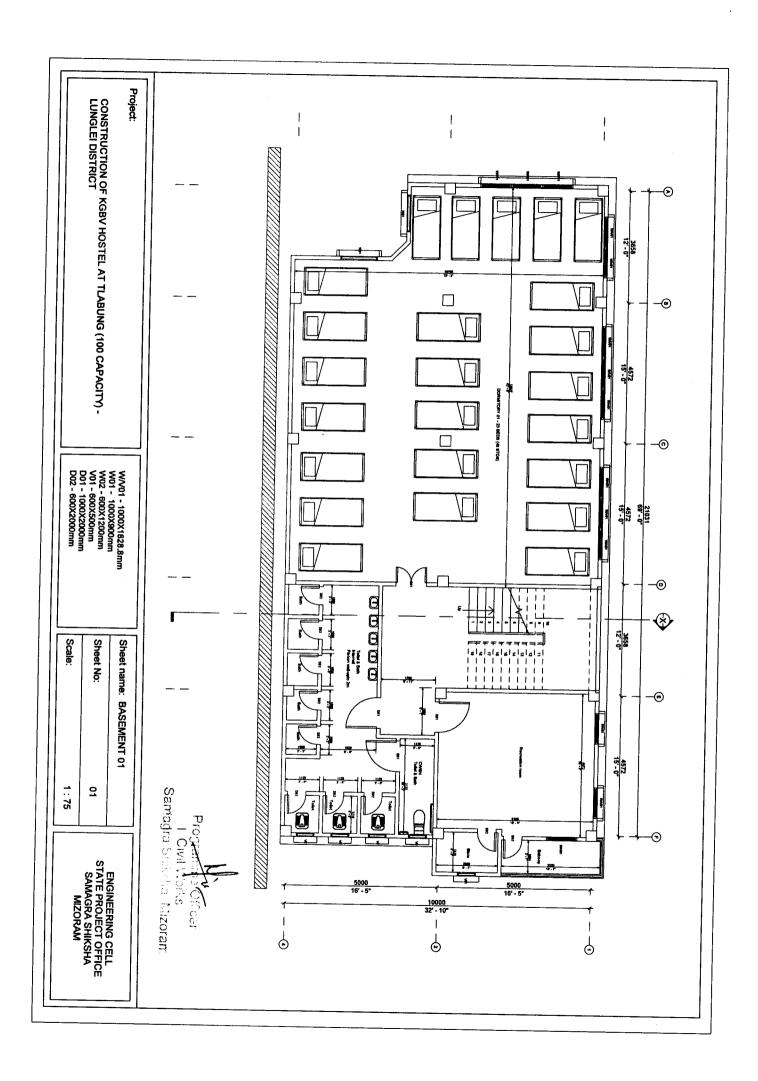
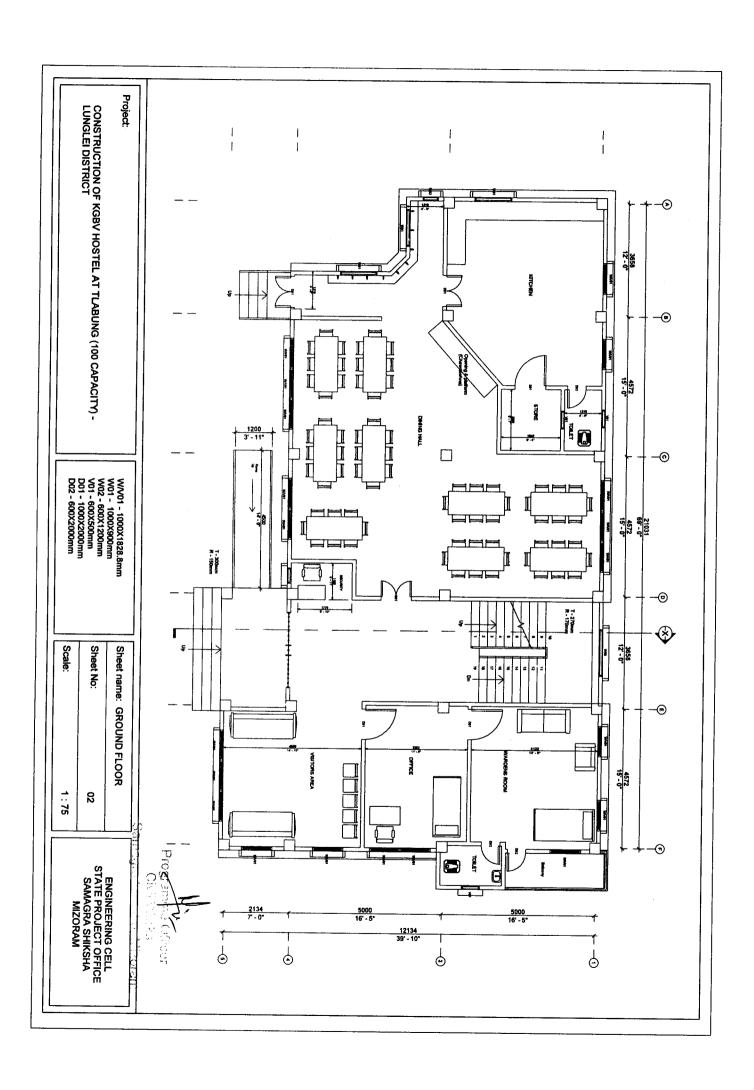
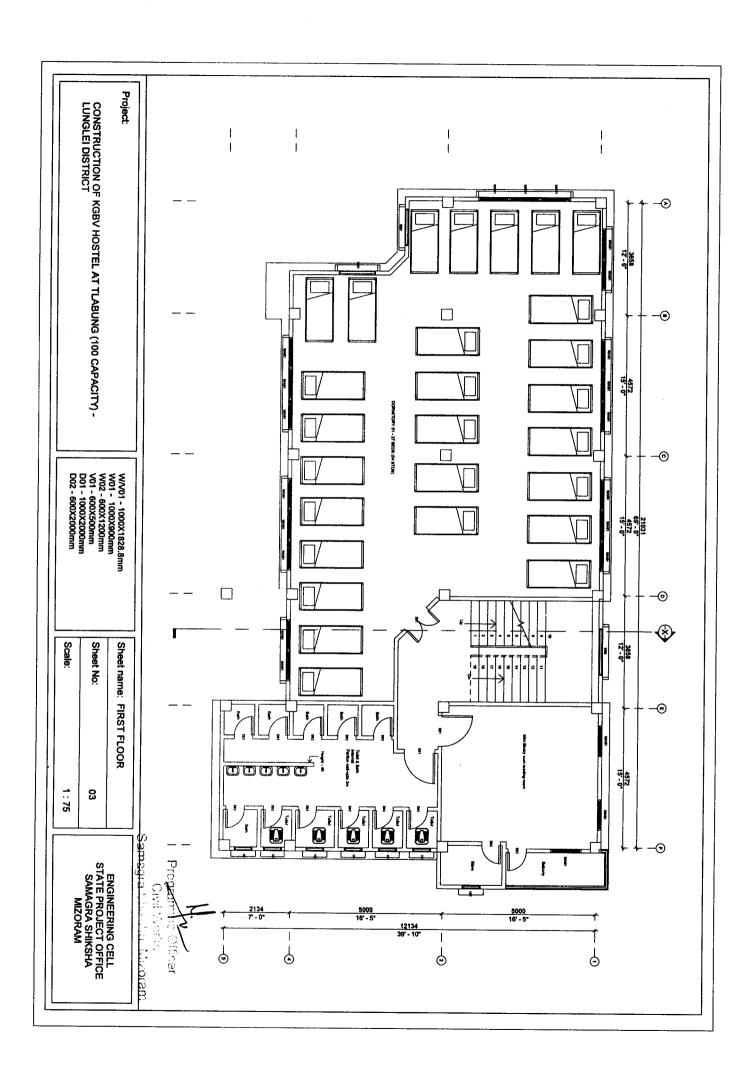
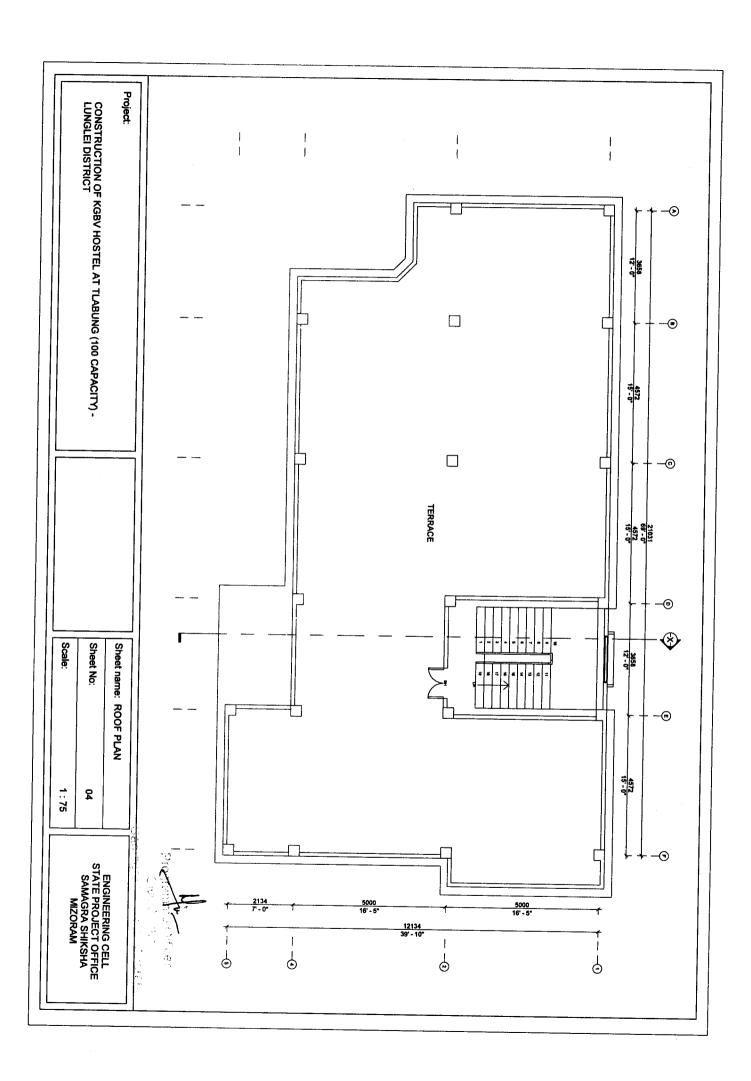
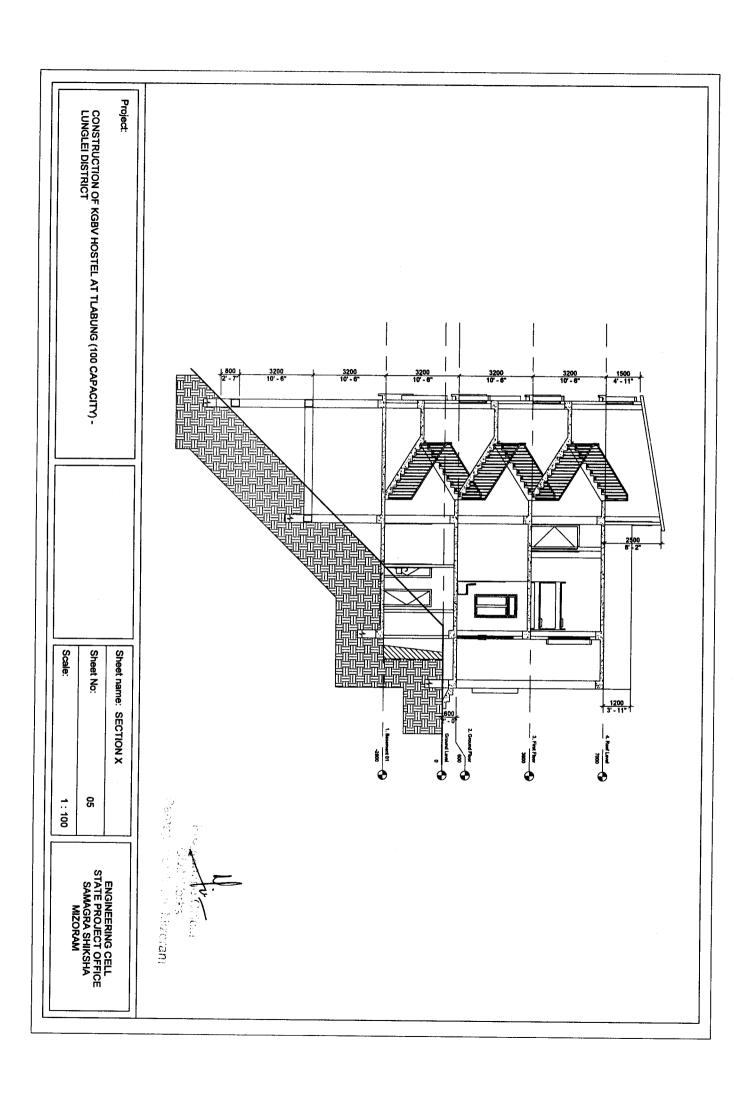
CONSTRUCTION OF KGBV GIRLS HOSTEL AT TLABUNG (100 Capacity), LUNGLEI DISTRICT

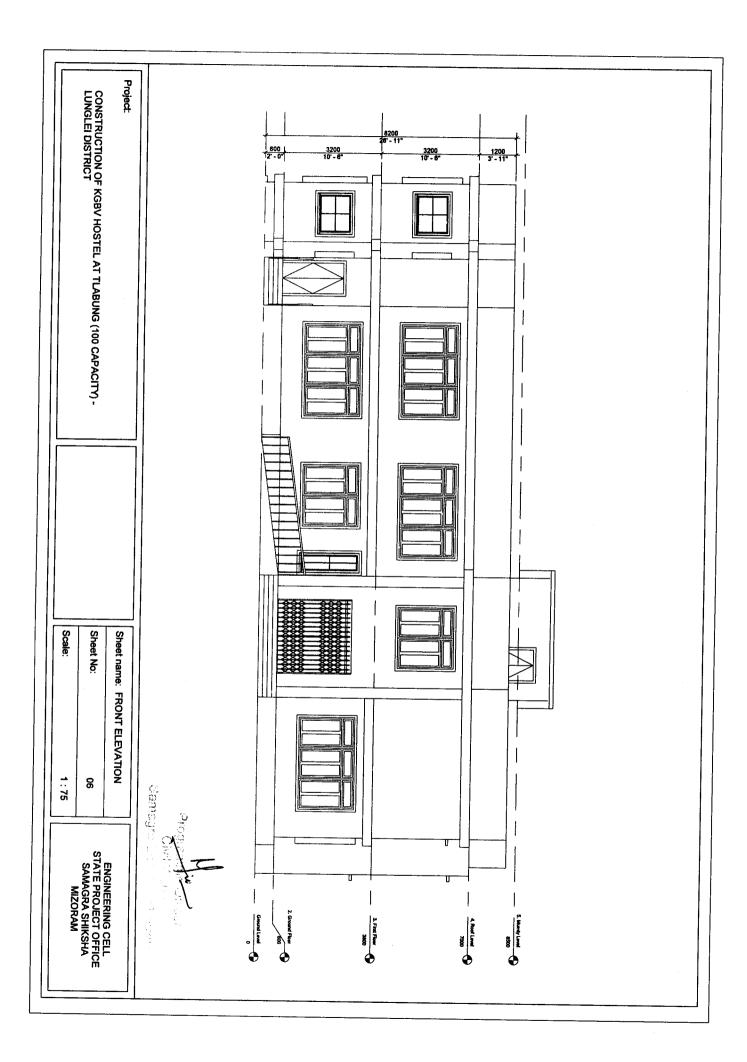


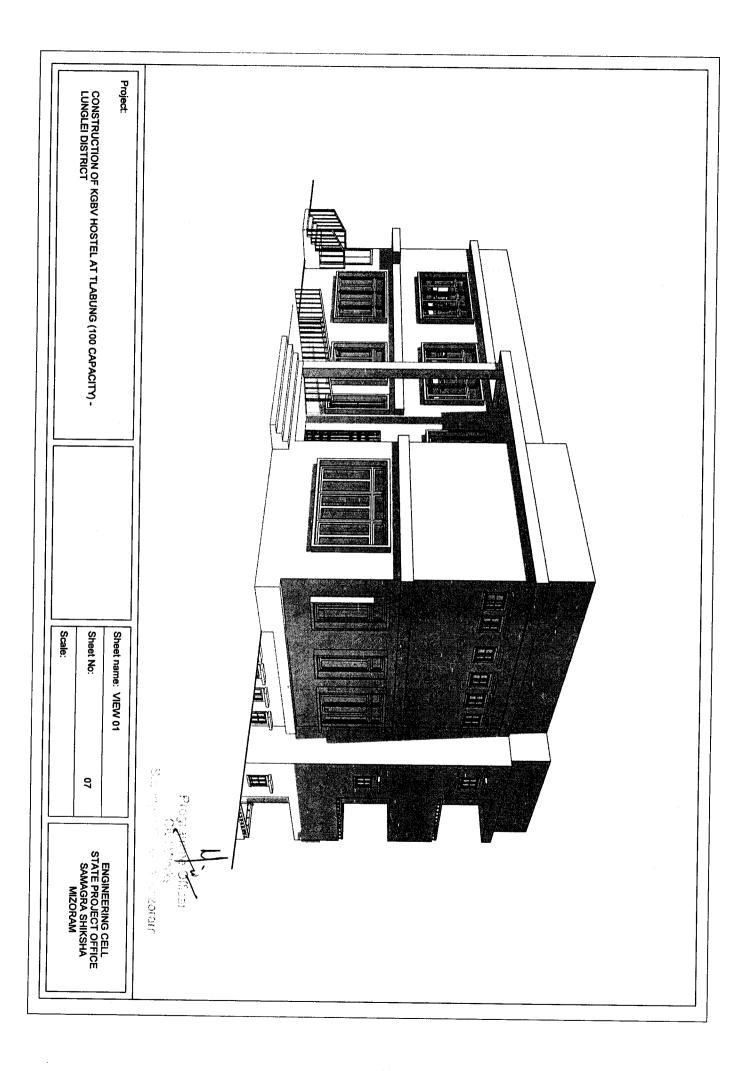















Project: CONSTRUCTION OF KGBV HOSTEL AT TLABUNG (100 CAPACITY) - LUNGLEI DISTRICT 1125 Sheet name: VIEW 02 Sheet No: 8 ENGINEERING CELL STATE PROJECT OFFICE SAMAGRA SHIKSHA MIZORAM il Linen

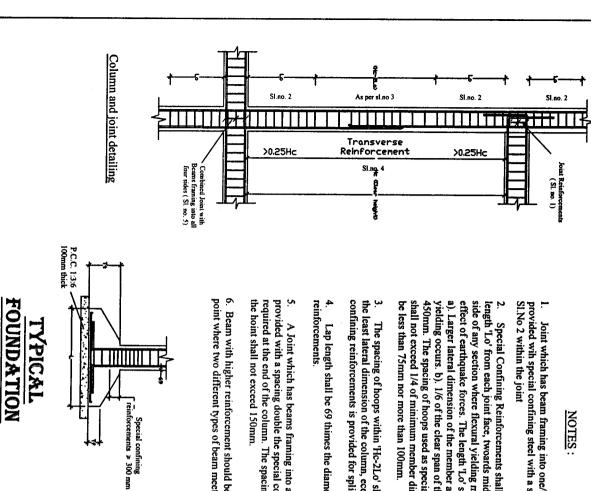Project: CONSTRUCTION OF KGBV HOSTEL AT TLABUNG (100 CAPACITY) - LUNGLEI DISTRICT Scale: Sheet name: VIEW 03 Sheet No: 9 ENGINEERING CELL STATE PROJECT OFFICE SAMAGRA SHIKSHA MIZORAM Chronette



- provided wih special confining steel with a spacing equal to SI.No 2 within the joint Joint which has beam framing into one/two sides shall be
- a). Larger lateral dimension of the member at the section where effect of earthquake forces. The length 'Lo' shall not be less than side of any section where flexural yielding may occur under the be less than 75mm nor more than 100mm. shall not exceed 1/4 of minimum member dimension but need no yielding occurs. b). 1/6 of the clear span of the member. c). 450mm. The spacing of hoops used as special confining steel length 'Lo' from each joint face, twoards mid span and on either Special Confining Reinforcements shall be provided over a
- confining reinforcements is provided for splice. the least lateral dimension of the column, ecept where special The spacing of hoops within 'Hc-2Lo' shall not exceed half
- Lap length shall be 69 thimes the diameter of longitudinal
- 5. A Joint which has beams framing into all four faces shall be provided with a spacing double the special confining steel the hoint shall not exceed 150mm. required at the end of the column. The spacing of the hoop within
- 6. Beam with higher reinforcement should be adopted at the point where two different types of beam meet

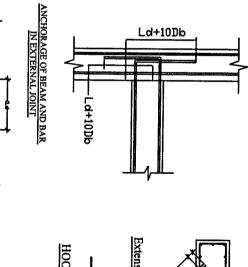

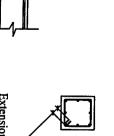

Extension of Hoop in column





DESIGNED

BY:

LAP SPLICE IN BEAM

Ld = Devlopment length in tension
Db = Bar diameter

(Er. DENNIS LALHLIMPUIA)

CONSTRUCTION OF KGBV TYPE-I BUILDING AT TLABUNG

Samagra Shiksha, Mizoram

State Project Engineer

Civil Works

FOR STRUCTURAL DETAILS GENERAL SPECIFICATIONS


Z T SCALE DRAWING <u>N</u>O:


ALL DIMENSIONS ARE IN MM

Civil Works

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FOUNDATION DETAILS



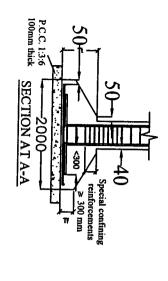

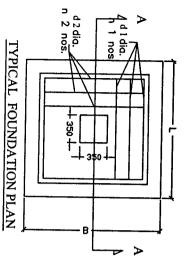			0	ooting:	
2000 X 2000	2000 17 2000	LXB	7	Dimensions:	ָּבָּר
150				7	
300			11	₹	
12 mm	2 . 2.2.	d I dia		L Dir	
20	11 1 1100.	n 1 nos		L Direction:	
12 mm	D1a. u 2	ניים	1 0 1	B Dire	
20	n z nos	3	. 1000	Direction ·	

Type of Fo

Ξ

NOTES:

- 1. P.C.C. 1:3:6 100mm thick shall be provided for levelling course below foundation.
- 2. Special confining reinforcement shall be extended at least 300mm into the footing or mat when column terminates into the footing of mat.
- 3. Clear Cover = 50 mm.
- 4. Concrete Grade = M20, Steel = Fe415(Tor Steel)

CONSTRUCTION OF KGBV TYPE-I BUILDING AT TLABUNG

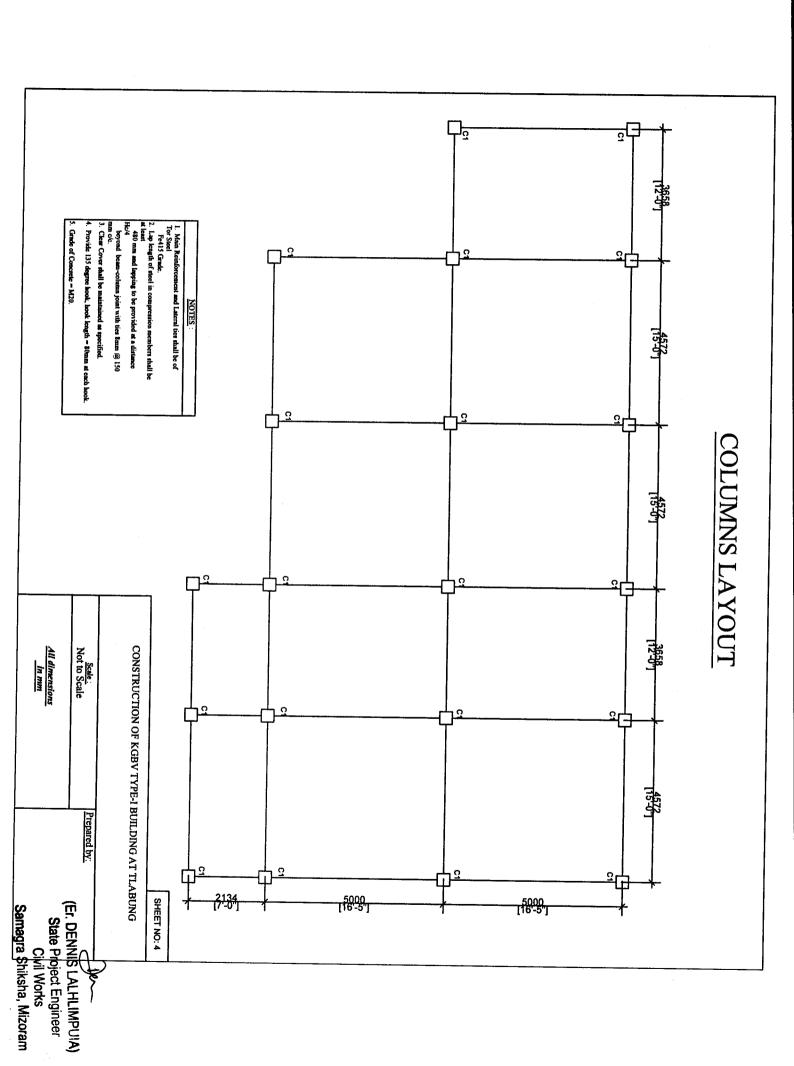
Not to Scale

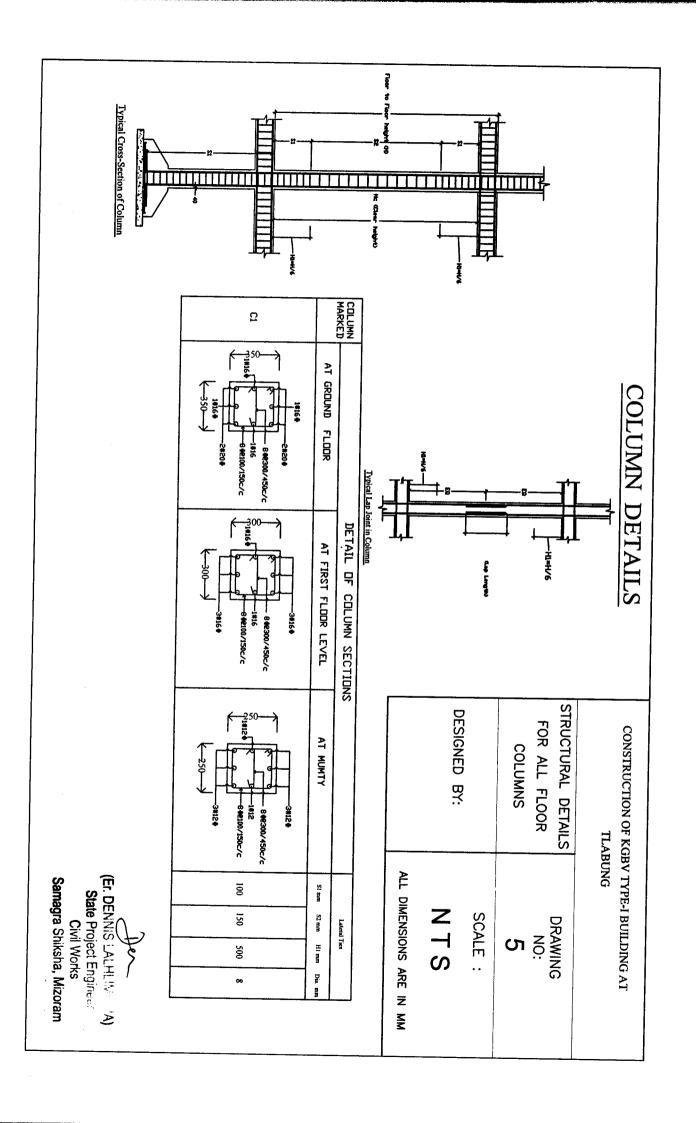
Not to Scale

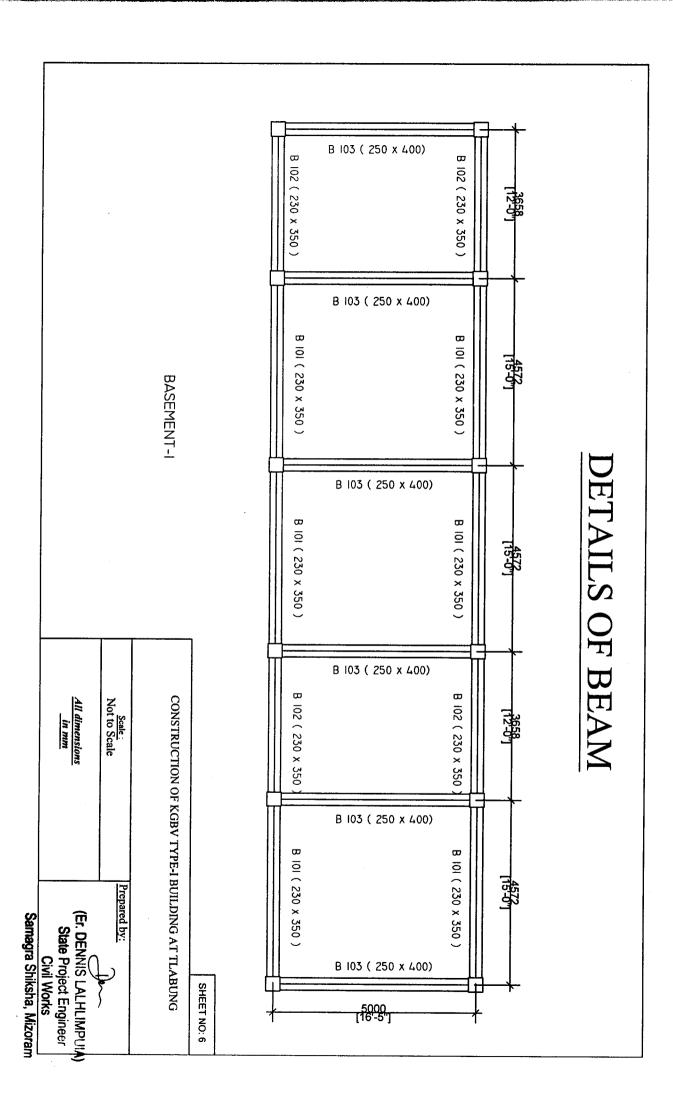
All dimensions
In min

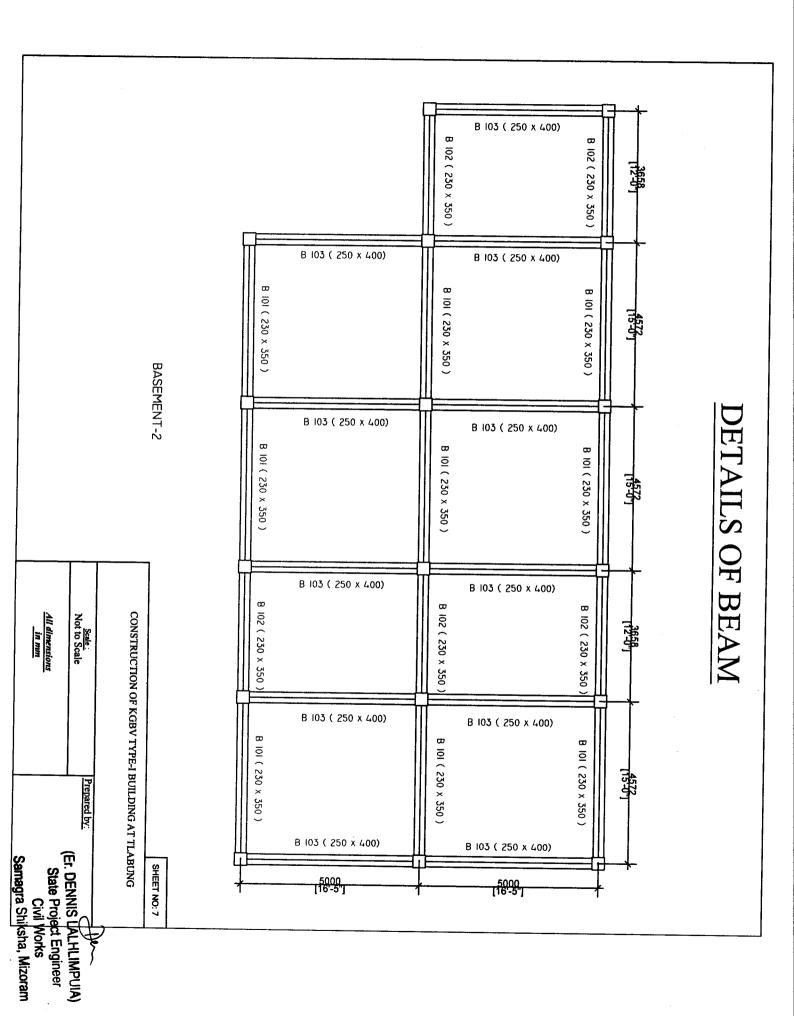
State Project Engineer
Civil Works

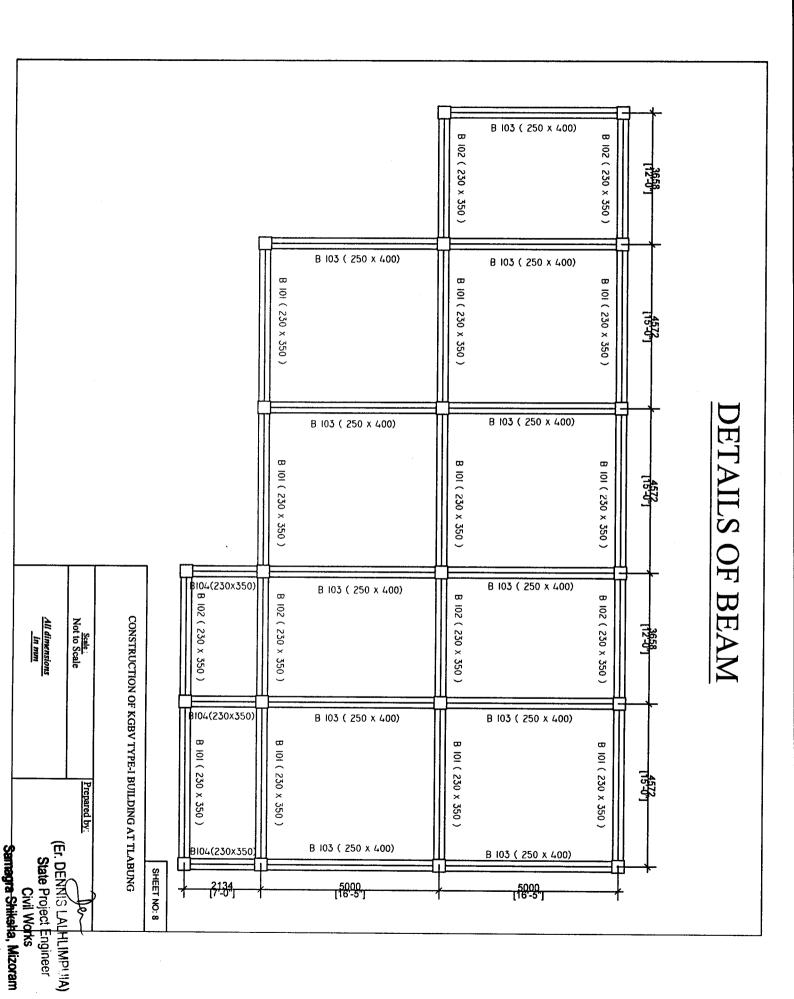
Samagra Shiksha, Mizoram












DETAILS OF BEAM

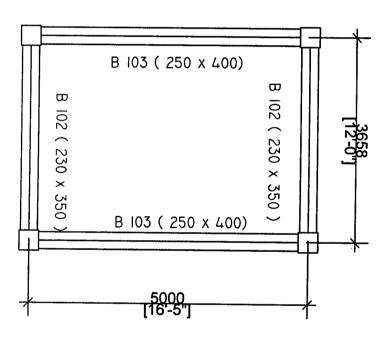


TERRACE LEVEL MUMTY BEAM


CONSTRUCTION OF KGBV TYPE-I BUILDING AT Scale: Not to Scale TLABUNG All dimensions in mm DESIGNED BY: (Er. DENNIS LALHLIM 'A)

SHEET NO: 9

Samagra Shiksha, Mizoram State Project Engineer
Civil Works

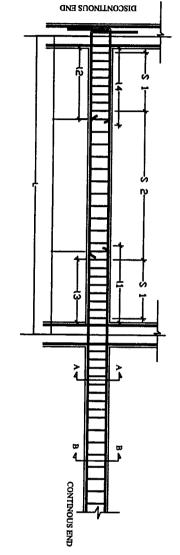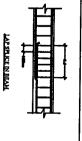TYPICAL LONG SECTION OF BEAM





Ld = Devlopment length in tension

Db = Bar diameter

- Where,

 SI = Spacing of stirrups for a length of 2d

 S2 = Spacing of stirrups in the mid-span

 Ld = development length of bar in tension

 L = Length of beam (C/C of column)

Typical long section of beam

B 104	B 103	B 102	Type of Beam	B 101	Type of Beam
230 x 350	250 x 400	230 x 350	Dimensions (mm)	230 x 350	Dimensions: (mm)
3816+	3 3 10 10 1 13	3#10.	Section at B-B'	3#10.	Section at B-B'
2#16+	2H16+	2#16.	Section at C-C	2#16+	Section at C-C
2134	5000	3658	(Mu) L	4572	3 }∟
640	1500	1100	€	1370	€.
320	750	550	(M) C 5	680	35 S
530	1250	909	(mg) (- 12	1150	(Sec. 3)
130	1000	730) (gg)	900	3.
Reum das Tor stock 2 leggest p 109 ann cir	Ram da Tor rheil 2 kgged g 100 mm cic	Ream die For steel 2 lagged p 100 mm c/c	\$ 1	Same dia. Tor steel. 2 lagged. 9 100 mm cr	2 1
Resent dan To'e reteck 2 keggeod 4 150 mas ce	lean da Tor seel 2 legged 9 150 non oc	teen de Tor steel 2 legged e 150 sen c'e	S	Bruge disa For sheet, 7 leggest, 9 150 man c/c	N N

SPECIFICATIONS:

- Clear Cover for Beam = 25mm.
- Grade of Steel = Fe 415
- Grade of Concrete = M 20
- 4. The first hoop shall be at a distance not exceeding 50mm from the joint face.

Minimum Curing Period = 28 days

Beam with higher reinforcement should be adopted at the point where two different types of beam meet.

SHEET NO: 10

CONSTRUCTION OF KGBV TYPE-I BUILDING AT TLABUNG

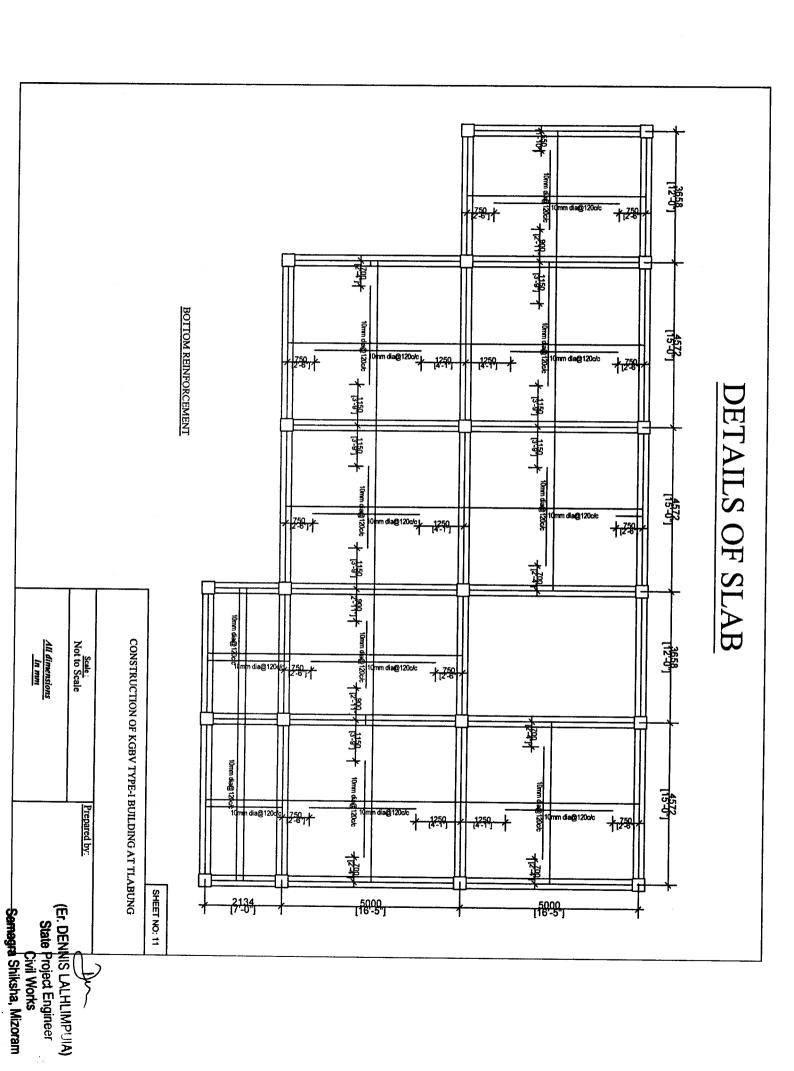
Certified that the requirements of Regulation 30 of the Aizawl Municipal Council Building regulations, 2012, have been complied with in the preparation of this structural drawing.

Scale: Not to Scale


All dimensions



Samagra Shiksha, Mizoram




DETAILS OF SLAB

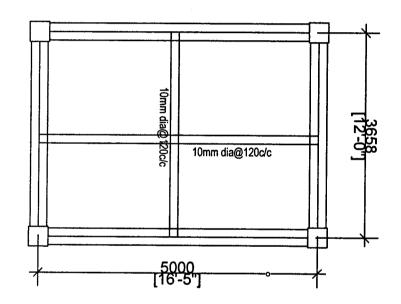



TOP & BOTTOM REINFORCEMENT TERRACE LEVEL MUMTY SLAB

CONSTRUCTION OF KGBV TYPE-I BUILDING AT Scale: Not to Scale TLABUNG All dimensions
in mm
DESIGNED BY:

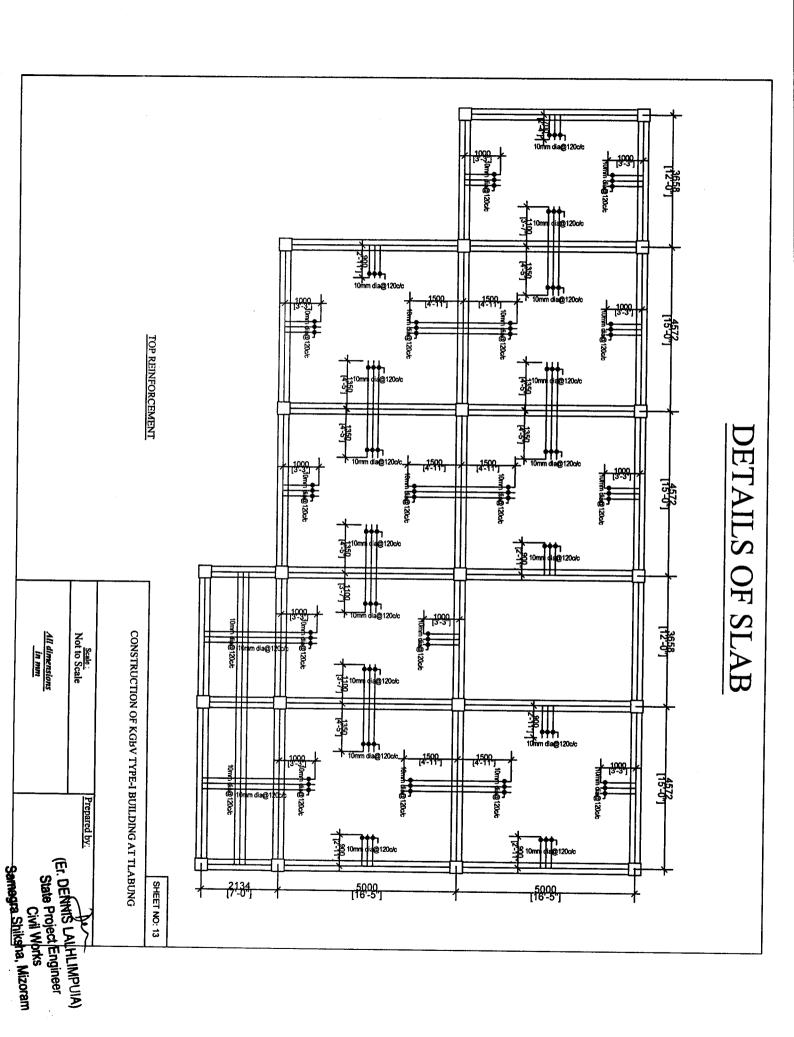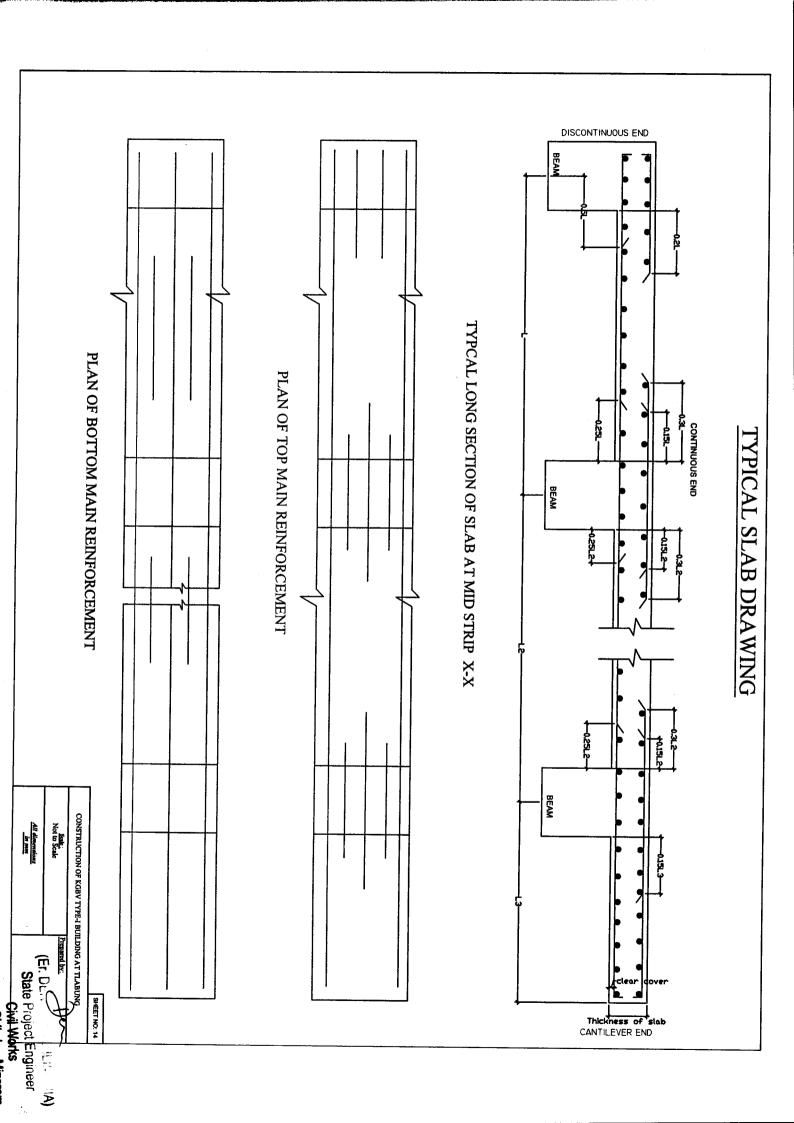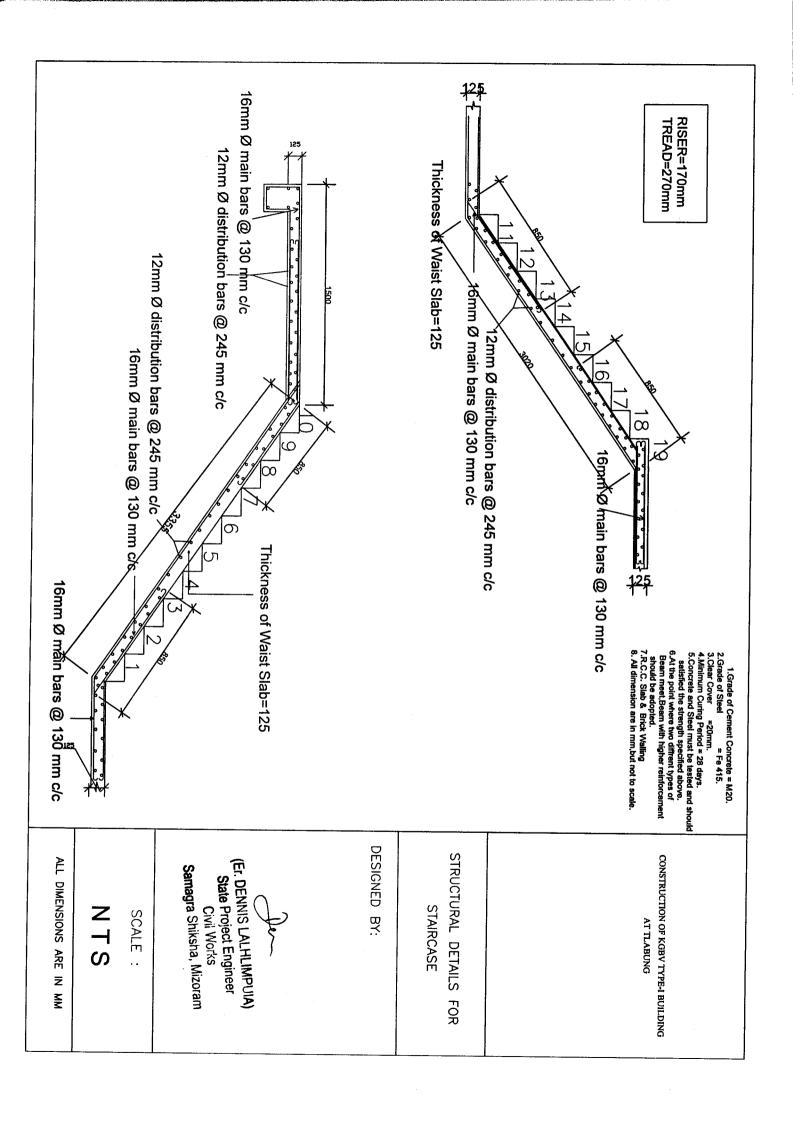SHEET NO: 12







BILL OF QUANTITIES FOR THE CONSTRUCTION OF KGBV TYPE I BUILDING AT TLABUNG (LUNGLEI DISTRICT)

	4/.		3/	T	2	,,,
	4/4.03		3/2.17		1/2.06	Sl.no
b) 1:3:6 (1 cement: 3 coarse sand: 6 graded stone aggregate 20mm nominal size)	Providing and laying in position cement concrete of specified grade excluding cost of centering and shuttering - All work upto plinth level:	2/3 of qty taken from 2/2.08	ruling available excavated earth (excluding rock) in trenches, plinth, sides of foundations etc. in layers not exceeding 20cm in depth, consolidating each deposited layer by ramming and watering, lead up to 50 m and lift upto 1.5 m.	(a) Uridinary Soil	Earthwork in excavation over areas (exceding 30cm in depth, 1.5m in width as well as 10sqm on plan) including disposal of excavated earth, lead upto 50m and lift upto 1.5m, disposed earth to be levelled and neatly dressed. (a) Oridinary and Hard Soil Earthwork in excavation in foundation trenches etc. not exceeding 2 meters depth including dressing of bottom and sides of trenches and subsequent filling and compaction in 15cm layers as in column foundations, fence posts, etc. and disposal of all surplus soil as directed within a lead of 30 metres.	Description of Items
cum		cum		cum	cum	Unit
25.50		106.667		160	377.052	Qty
					e de la companya de l	in film
					in words	Rate
						Amount

(Er. DE: ... S LALHLIMPUIA)
State Project Engineer

	8/5.18		7/5.03		6/5.02			5/5.01
b) Thermo-Mechanically Treated Bars	Steel reinforcement for RCC work including straightening, cutting, bending, placing in position and binding all complete	a) l:1.5:3 (I cement: 1.5 coarse sand: 3 graded stone aggregate 20mm nominal size)	Reinforced cement concrete work in beams, suspended floors, roofs having slope up to 15° landings, balconies, shelves, chajjas, lintels, bands, plain window sills, staircases and spiral stair cases above plinth level up to floor five level, excluding the cost of centering, shuttering, finishing and reinforcement complete.	a) 1:1.5:3 (I cement : I.5 coarse sand : 3 graded stone aggregate 20mm nominal size)	Reinforced cement concrete work in walls including attached pillasters, columns, pillers, posts, piers, abutments, return walls, retaining walls, struts, buttresses, string or lacing courses, fillets etc. upto floor five level excluding cost of centering shuttering etc complete.	(a) 1:1.5:3 (1 cement: 1.5 coarse sand: 3 graded stone aggregate 20mm nominal size)	All work upto plinth level:	Providing and laying in position reinforced cement concrete excluding cost of centering and shuttering, finishing and reinforcement in-
kg		cum		cum		cum		-
40723.971		183.03		29.43		27.252		



	67.62	sqm	a) 40 mm mick.	a
			_ 1	5,
			complete.	
			panelled shutters for doors etc. including M.S. hutt hinges with necessary screws at	13/9.10 p
			Providing and fiving 1st class teat wood	Ð
	2.018	cum	of chaukat for doors, windows, clerestory windows fixed in position.	12/9.06 o
	95	sqm	(b) sand) In cement mortar 1:4 (1 cement : 4 fine	
			brick in superstructure above plinth level upto floor two level including curing, etc. complete.	11/6.09 b
	697.340	sqm	a) In cement moratar 1:3 (1 cement: 3 coarse sand)	2 2
			1278 2	10/6.06 s
	29.38	sqm	excluding landings.	
			f) Staircases (except spiral staircase)	f
	955.83	sqm	e) Suspended floors, roofs, landings, shelves and their support, balconies and chajjaj,etc.	0
	457.38	sqm		
	210.00	sqm	250X400	
	247.38	sqm	230x350	
			d) Lintels, beams, plinth beams, girders, bressumers and cantilevers, etc.	
	364	sqm		
			and struts.	
			- 1	
			propping, etc. and removal of form works in -	9/5.10

(Er. DENNIS LALHLIMPUIA)
State Project Engineer

	17/10.09		16/20.08		15/11.02			14/11.01
apart weided with base plate of 60mmx3mm thick and fixed with cement grouting firmly to concrete section including steel priming ans steel painting complete etc.	or circular section decorative intermediate balusters welded to top and bottom rails at 280mm apart. The base of balusters at 560mm	consisting of top and bottom rails of 40mmx40mm square or circular section at distance of 788mm apart, 30mmx30mm square	sand).	a) 4mm thick plate sheet glass.	Supplying of glass panes at site	(i) 2 - track sliding windows/ventilators.	(b) Natural Colour	froviding and fixing anodised aluminium work for doors, windows, ventilators and partitions with extruded built up standard sections/ other sections of approved make conforming to IS: 733 and IS: 1285 fixing with dash fasteners of required dia and size, including necessary filling up of gaps at junctions, at top, bottom and sides with required PVC/ neoprene gaskets etc. Aluminium sections shall be smooth, rust free, straight, mitred and jointed mechanically wherever required including cleat angle, aluminium snap beading for glazing /panelling, CP brass /stainless steel screws all complete including fixing of glasses but excluding cost of glasses.
	sqm		sqm	sqm		sqm		
	58.10		4135.69	127.87		127.87		

23/7.01		22/20.50		21/20.75		20/20.72	19/20.51		18/12.11
C) in cement mortar 1:6 (1cement:6 fine	Regular coursed rubble masonry with hard stone in foundation upto one storey above and below ground level including curing, etc. complete.	Applying one coat of water thinnable cement primer of approved brand and manufacture on wall surface:	a) Regular exterior emulsion like supercote, walmasta etc.	Finishing walls with exterior emulsion of required shade on new work (three or more coats) to give an even shade.	a) General quality	Painting with synthetic enamel paint of approved brand and manufacture in all shades on new work (two or more coats).	Applying priming coat with ready mixed pink or Grey primer of approved brand and manufacture on wood work (hard and soft wood) & Plywood.	b) Matt/Antiscratch	Providing and laying ceramic glazed floor tiles of size 300x300mm or more (thickness to be specified by the manufacturer) of 1st quality conforming to IS: 15622 of approved make in all colours, shades, except white, ivory, grey, fume red brown, laid on 20mm thick cement mortar 1: 4 (1cement: 4 course sand) including pointing the joints with white cement and matching pigments etc. complete. as per designed colour.
Cim		sqm	sqm		sqm		sqm	sqm	
55.07		4135.69	4135.69		195.792		195.79	131.14	
		-							



24/14.11 lever mortise door lock with necessary screws, etc. complete. a) Union type Providing and fixing M.S. Tower bolts (socket bolts) bright finished with necessary screws etc. complete. (a) 1300 mm Providing and fixing M.S. handles with necessary screws etc. complete. (a) 1150mm Providing and fixing on terrace (at all Joor levels) Polyethylene storage tank of approved brand and manufacture with cover and mosquito proof coupling and suitable locking arrangement and making nescessary connections for inlet, outlet and overflow pipes but without the cost for base support. [a) Sintex or quivalent providing and fixing on wall face SWRPVC soil, waste and vent pipes including jointing with rubber lubricant/cement solvent complete. [a) 110mm dia. Providing and fixing SWRPVC plain bend of required degree (45°) including jointing with rubber lubricant/cement solvent complete. [a) 1110 mm dia. Providing and fixing SWRPVC plain bend of required degree (45°) including jointing with rubber lubricant/cement solvent complete. [a) 1110 mm dia. Providing and fixing SWRPVC plain bend of required degree (45°) including jointing with rubber lubricant/cement solvent complete. [a) 1110 mm dia. Providing and fixing SWRPVC plain bend of required degree (45°) including jointing with rubber lubricant/cement solvent complete.	
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(Er. DENNIS LALHLIMPUIA)
State Project Engineer
Civil Works

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	9				36/18 00 1	-	0.0710.07					34/18.02	·						33/17.04	-						32/17.42			31/17.37
	b) 20 mm nominal bore	making long screws etc. complete (New work).	including cutting and threading the pipe and	in order in the lixing G.I. Union in G.I. pipe	Providing and Editorie	h) 20mm nominal base	quality.	Providing and fixing brass bib cock of approved	a) 20mm dia nominal bore	exposea on wall).	making good the walls etc. (internal works-	G.I. fitting and clamps, including cutting and	Providing and fixing G.I. pipes complete with	(i) White		good the walls and floors wherever required:	lixtures complete, including cutting and making	conforming to IS: 7231, with all fittings and	with manually controlled device (handle lever),	P.V.C. flushing cistern, including flush pipe.	with seat and lid, 10 litre low level white	type water closet (European type W.C. nan)	Providing and fixing vitrous ching podental	a) 110 mm dia.	complete.	jointing with rubber lubricant/cement solvent	Providing and fixing ventilation cowl including	a) 110x110x110 mm	plain junction of required degree (T-junction).
1405	Nos				Nos				rm					Nos									NOS	No				Nos	
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40/17.24	39/10.18			38/18.51			37/17.16
Providing and fixing mirror of superior glass (of approved quality) and of required shape and size with plastic moulded frame of approved make and shade with 6 mm thick hard board backing:	Providing and fixing M.S. grills of required pattern in frames of windows etc. with M.S. flats, square or round bars etc. including priming coat with approved steel primer all complete.		(b) 750 watts	Providing and placing in position electric water pump of approved manufacture including connections to G.I pipes etc. complete with accessories.	i) white	a) Vitreous China Wash basin size 630x450 mm with single 15 mm C.P. brass pillar taps	Providing and fixing White vitreous china wash basin Standard of Parryware/ Hindware/ Cera and equivalent make with R.S. or C.I. brackets, 15mm C.P. brass pillar taps, C.P. brass chain with rubber plugs, 32mm C.P. brass waste of standard pattern, 32mm C.P. brass traps and union complete including painting of fittings and brackets, cutting and making good the walls wherever required.
Nos	sqm		each		Nos		
26.00	136.09		1.00		11.000		



[T	1 -		Т	<u> </u>
	3/5.10		2/5.03		1/2.08		41/10.04
(e) Suspended floors, roofs, landings,	Centering and shuttering including strutting, propping, etc. and removal of form works in -	(a) 1:1.5:3 (1 cement : 1.5 coarse sand : 3 graded stone aggregate 20mm nominal size)	Reinforced cement concrete work in beams, suspended floors, roofs having slope up to 15° landings, balconies, shelves, chajjas, lintels, bands, plain window sills, staircases and spiral stair cases above plinth level up to floor five level, excluding the cost of centering, shuttering, finishing and reinforcement complete.	(a) Oridinary Soil	Earthwork in excavation in foundation trenches etc. not exceeding 2 meters depth including dressing of bottom and sides of trenches and subsequent filling and compaction in 15cm layers as in column foundations, fence posts, etc. and disposal of all surplus soil as directed within a lead of 30 metres.	SEPTIC TANK	steel shutters with vertical channels 20x10x2mm and braced with flat iron diagonals 20x5mm size with top and bottom rails of T- iron 40x40x6mm with 40mm dia. steel pulleys complete with bolts, nuts, locking arrangement, stoppers, handles, including applying a priming coat of approved steel primer.
m²		m ³		m ³			sqm
4.671		1.185		19.760			7.56

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Civil Works

Crand Total				
Crand Tatal.				
Add 1% for Labour Cess				
Add 6% for GST				
Total inclusive of Cost Indices				
Add 34.55 % C.I for Lunglei District				
Total				
	3.68	m²	sand)	
			1 2 4	
			class brick in foundation up to one storey above	
			ļ	//6.08
	6.28	m²	ļ	
			bric	6/6.09
			7 5 cm thick baids	
	66.87	kg	(b) Thermo-Mechanically Treated Bars	
				5/5.18
	8.365	m²		4/20.08

BILL OF QUANTITIES

NAME OF WORK: INTERNAL ELECTRIFICATION OF KGBV HOSTEL, TLABUNG; LUNGLEI DISTRICT

C:02:00	SURFACE PVC CASING &CAPPING COPPER WIRING (GRADE-II) LIGHT POINT, CEILING FAN POINT, EXHAUST FAN POINT ETC [MODULAR TYPE] Wiring in looping system with PVC wire sheathed standard copper conductor/wires as per IS:694 (1990) and Flame retardant low smoke & Halogen (FR-LSH)1100 voltage graded copper flexible wire stranded copper running inside PVC casing &			11 11 m	TI WOLUS
C:02:01	retardant low smoke & Halogen (FR-LSH)1100 voltage graded copper flexible wire stranded copper running inside PVC casing & capping (Gr-II) 20mm dia fixed, surface on the wall/ceiling/floor as per convenience including junction box having required numbers of ways from control switch to the light point etc as required:-				
	C:02:01 (B) Short Point (Modular) C:02:01 (C) Medium Point (Modular)	Each	30		
	FAN POINT	Each	26		
	C:02:01 (D) Long Point (Modular)	Each	19		
	LIGHT PLUG/SOCKET POINT 5/6 AMPERES (MODULAR TYPE) Wiring in looping system with PVC wire sheathed standard copper conductor/wires as per IS:694 (1990) and Flame				
c:02:02 copper flexible wire stranded copper running inside P capping (Gr-II) 20x12mm fixed, surface on the wall/ce as per convenience including junction box having requnumbers of ways from DB to the light plug/socket 5/6 etc. as required:-	retardant low smoke & Halogen (FR-LSH) 1100 voltage graded copper flexible wire stranded copper running inside PVC casing & capping (Gr-II) 20x12mm fixed, surface on the wall/ceiling /floor as per convenience including junction box having required numbers of ways from DB to the light plug/socket 5/6A point etc. as required:-				
_					



 						1:02:00														C:02:06											C:02:03			
1:02:03 1 S two ways	1:02:01 1 \$	One Module Switch Board (Modular)	fan regulators etc. with necessary painting if necessary	boxes, modular plate and necessary switches, plug/socket, and	following sizes/modules on surface/recess including PVC/Steel	Supplying and fixing of Modular switch board grade-II of the	grade-II	SUPPLYING AND FIXING OF SWITCH BOARDS (MODULAR TYPE)	earth wire	C:01:06(C) 2X 6 Sqmm copper conductor/cable + 1 x 6 Sqmm	wire	C:02:06(B) 2X4 Sqmm copper conductor/cable + 1x4 Sqmm earth	earth wire	C:02:06(H) 2X7.5 Samm conner conductor/cable + 1v2 E samm	boards as required:-	Main/DB/Sub-Main/DB to SDB/SDB/Switch boards/SDB to switch	box having required numbers of ways from Main to Sub-	on the wall/ceiling/floor as per convenience including junction	& capping (Grade-II) of all available sizes diameter fixed, surface		retardant low smoke & Halogen (FR-LSH) 1100 voltage graded	copper conductor/wires as per IS:694 (1990) and Flame	Wiring in looping system with PVC wire sheathed standard	(SINGLE PHASE TWO WIRES)	MAIN TO SUB-MAIN IN COPPER WIRE GRADE-II SURFACE	C:02:03(D)Power plug Point 15/16 A Long Point (Modular)	required:-	ways from DB to the nower plantsocket 15/164 point of	convenience including in the wall/ceiling /floor as per	wire stranded copper running inside PVC casing & capping (Gr-II)		conductor/wires as per IS:694 1990) and Flame retardant low	Wiring in looping system with PVC wire sheathed standard compared.	POWER PLUG/SOCKET POINT 15/16 AMPERES (MODULAR
8	N _O								∄		m		Ħ							_						Each							•	
4	11								100		142		540													6								
			•																				•											

(Er. DENNIS LALHLIMPUIA)
State Project Engineer

	J:01:00									J:00:00			0:03:00			0:00:00				N:01:00			1.00.0				
Havells/equivalent 2005W GFL Retro ZING 2 Polycarbonate flood light luminaire for twin high Wattage Retrofit CFL.	(Phillips/equivalent) (Phillips/equivalent)	(1375) LED Batten fitting 1X12W Linea 2' with LED tube (Phillips/equivalent)	Sqmm copper conductor single core cable etc as required.	flourescent Light fittings of all types, with all accessories and tubes etc, directly on ceiling/wall. including connection with 1.5	J:01:30 Installation, testing & commissioning of pre-wired	(1661) CFL Curvy 15W(SP) B22,E27 Base Havells/Equivalent	connection etc, as required	J:01:03 Supplying, fitting and fixing Batten Holder including	LIGHTING FIXTURES CEILING/WALL MOUNTED:-	LIGHTING FIXTURES(SURFACE/RECESS)	O:03:75 6-ways MCB DB SP & N DD metallic Door	required.	 	Supplying, fitting, & fixing of 63 Amps' 6-ways Distribution Board	MCB DISTRIBUTION BOARD	DISTRIBUTION BOARDS	N:01:27 63 Amps' DP, MCB Isolator	N:01:01 5 to 32 Amps ,SP, MCB B- series	complete with connecti		Supplying and fixing of all types and rating MCBs, RCCBs, ELCBs	MCBs SP/SP&N/DP/TP/TP&N/FP	SP/SPN/DP/DP&N/TP/TP&N/FP	MCBs/RCCBs/ELCBs/MCCBs/EARTH FAULT RELAY	I:02:86 2S+1R+1SOC	Six modules Switch Board (Modular)	1:02:13 25
No	No	No		Each		No	Each				Each						Each	Each		•					8		No
H	42	10	53			30	30				ß						ω	12							19		14


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		-		L	
				:00 LIGHTNING CONDUCTOR	R:01:00
				i	
		e 772.8	Metre	copper conductor for loop earthing in the existing surface/recess steel/PVC conduit/PVC cassing & capping	
			1	0:01:55 Supplying and drawing of 1 5 samm DVC shoothad	
	-		,-	etc. as required. (8 SWG Copper Wire (4mm dia '))	
		e 18	Metre	ground level for conductor earth electrode, including soldering	
				Q:01:38 Supplying & Laying of 8 SWG Copper Wire at .50mbelow	
		,			C:01:00
		<u> </u>	Each		
				Q:01:10 Extra for using salt and coke for G.I or copper plate earth	
				and salt) complete as required.	·
				arrangment and water pipe, etc. (but without charcoal or coke	
			Each	providing masonery enclosure with cover plate having locking	
				thick including accessories and	
			_	Ա:01:0/ Earthing with Copper Earth plate 600mmx600mmx6mm	
				EAN I TING AND LOOP EAR I HING	•
		,	\dagger	CARTINIC AND LOOP TARTINIC	
		س	No	Rio /Equivalent	
				(1828) Electric Storage Water Heater/Geyser 6 litres 2 KW Havells	
		ω		required.	
				good the damage, connection, testing and commissioning etc, as	
			raci		J:02:00
· · · ·				to 50 litres in the existing wall including fixing the Hook in the	
				J:02:02Installation of Instantaneous Electric Water Heater up	
				J:02:00Installation of all kind of Electrical appliances	
		19	NO	(Usha/Crompton/Equivalent)	
			•	(1845)Ceilling fan 1200mm Sweeps ISI marked 3 blades	
		2	NO	remote ISI marked (Usha/equivalent)	
				(1861)Bracket wall mounting fan 400mm sweeps Helix with	
		21		core cable etc, as required	-
_			Each	30cm) with 2X1.5 sqmm PVC insulated copper conductor single	
•				regulator, including wiring the down rod of standard length (upto	
				J:01:36 Installation, testing & commissioning of ceiling fan and	

		RS	GRAND TOTAL
			Add 1% Labour Cess
			Add 18% GST
			Total
			cable lump sum
			3- Phase Service connection 25sqmm four core Aluminium
•	U	EdCII	pipe line as required in lump sum
	3	1	Supplying and fitting of Water Cooler 120 ltrs with water
	20	MELIE	from earth electrode directly in ground as required.
	3		R:01:67Providing and laying of copper tape 32mmx6mm thick
			in complete
	-	Each	with base plate to mount lightning Arrestor (DOKSUN/Equivalent)
	.	<u> </u>	lightning Arrestor 50m 3 meters long made of SS-304 material
			R:01:10Providing and fixing of Stainless steel pole for ESE
			second delay (DOKSUN/equivalent)
			of 63m diameter lightning charge capacity 100 KA and 43 micro
	1 -	Eacn	Duly tested and certified by CPRI Bangalore, Having coverage area
	.	1	standardized according to norms UNE 21.186 AND NPC 17.102
			6.5 (DPDC 6.5) with non electric ESE(Early steamer Emission)
			K:U1:U8Providing and fixing of ESE type lightning Arrestor PDC


(Er. R. LALNUNFELA)
Programme Officer
Civil works
Samagra Shiksha, Mizoram

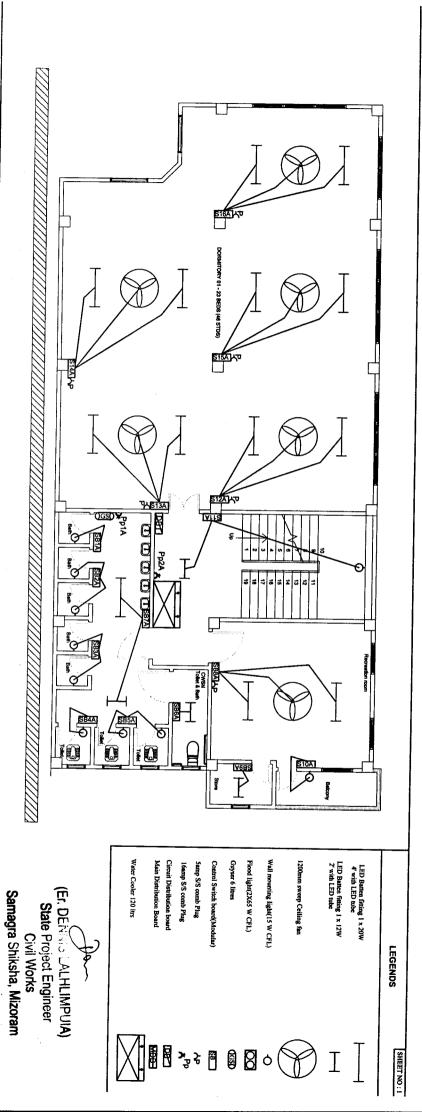Rupees in words



(Er. R. LALNUNFELA) Programme Officer Civil works

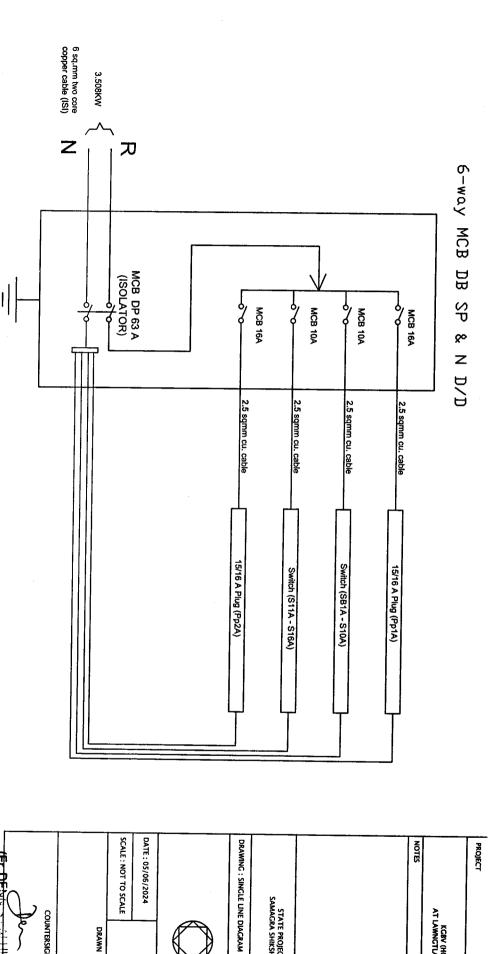Samagra Shiksha, Mizoram



STATE PROJECT OFFICE SAMAGRA SHIKSHA, MIZORAM

KGBV (HOSTEL) AT LAWNGTLAI DISTRICT

Samagra Shiksha, Mizoram (Er. R. LALNUNFELA)
Programme Officer Civil works




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Programme Officer

(Er. DENNÍS LALHLIMPUIA)

State Project Engineer Civil Works


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6-way MCB DB SP & N D/D

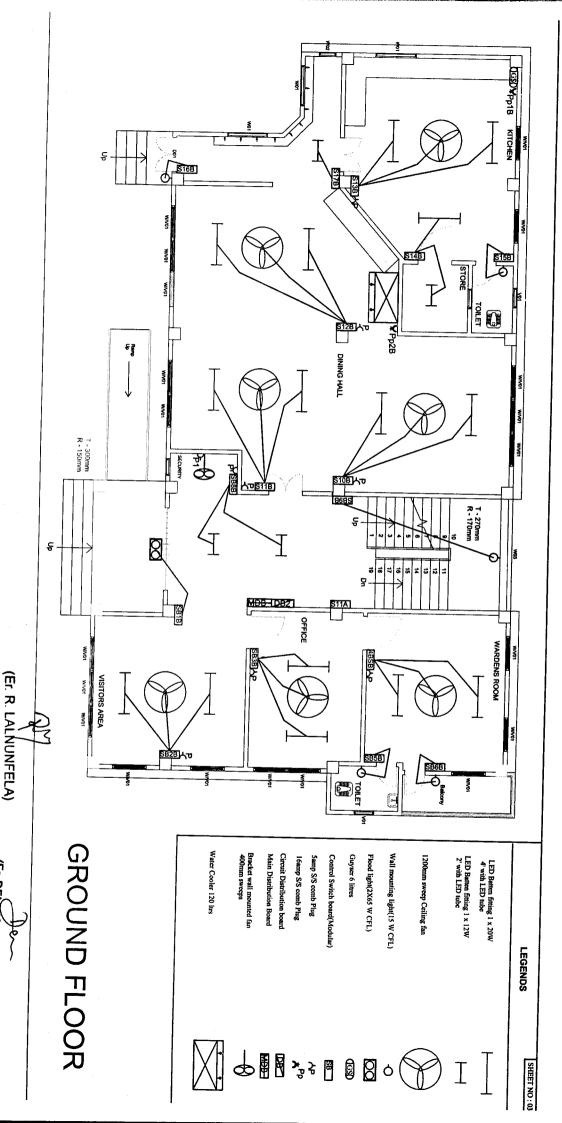NOTES

KGBV (HOSTEL) AT LAWNGTLAI DISTRICT

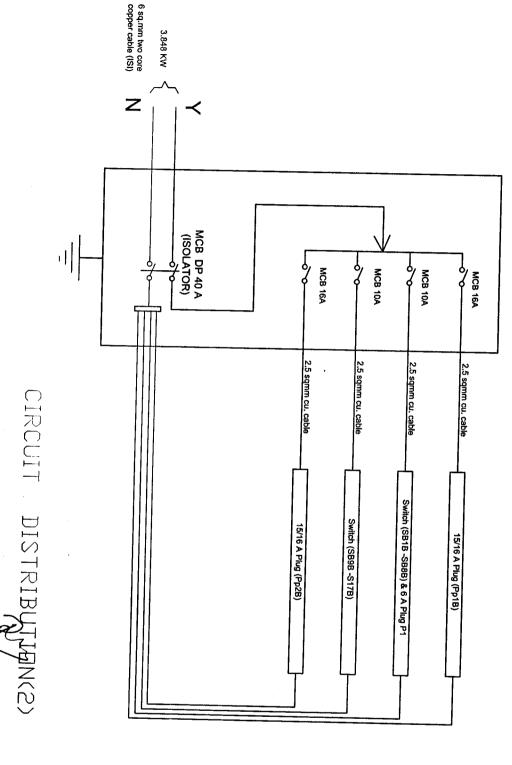PROJECT



DRAWING: SINGLE LINE DIAGRAM

STATE PROJECT OFFICE SAMAGRA SHIKSHA, MIZORAM

SCALE: NOT TO SCALE DATE: 05/06/2024

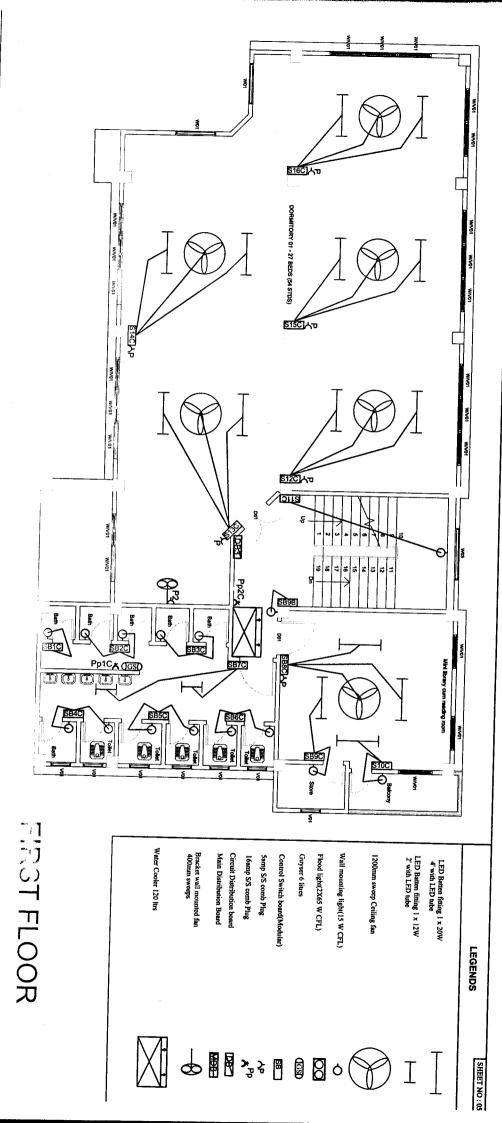
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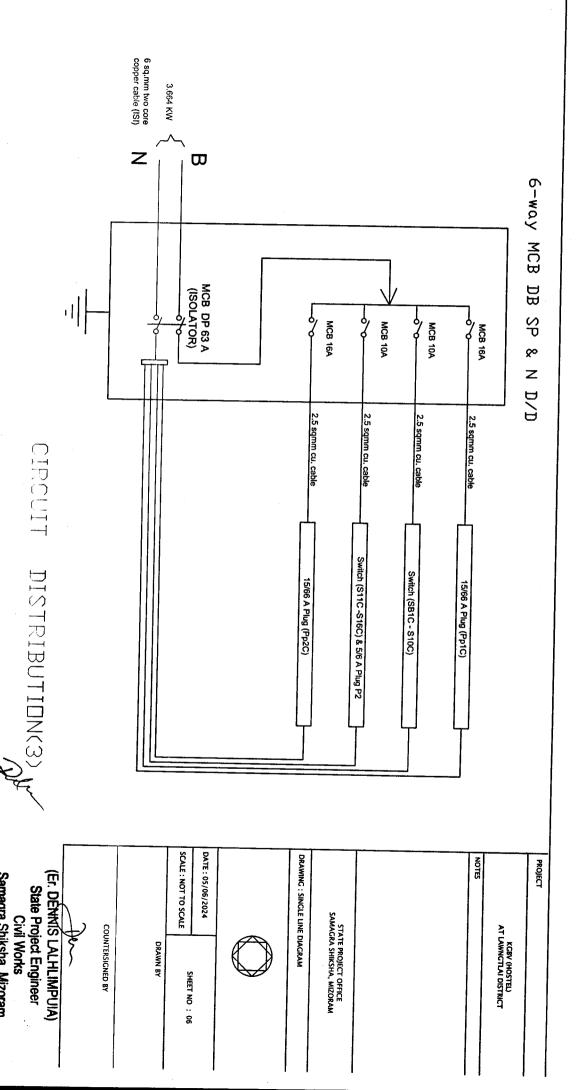
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Samagra Shiksha, Mizoram

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