




### THINGFAL HIGHER SECONDARY SCHOOL-ARTS STREAM AT LUNGLEI DISTRICT CONSTRUCTION OF

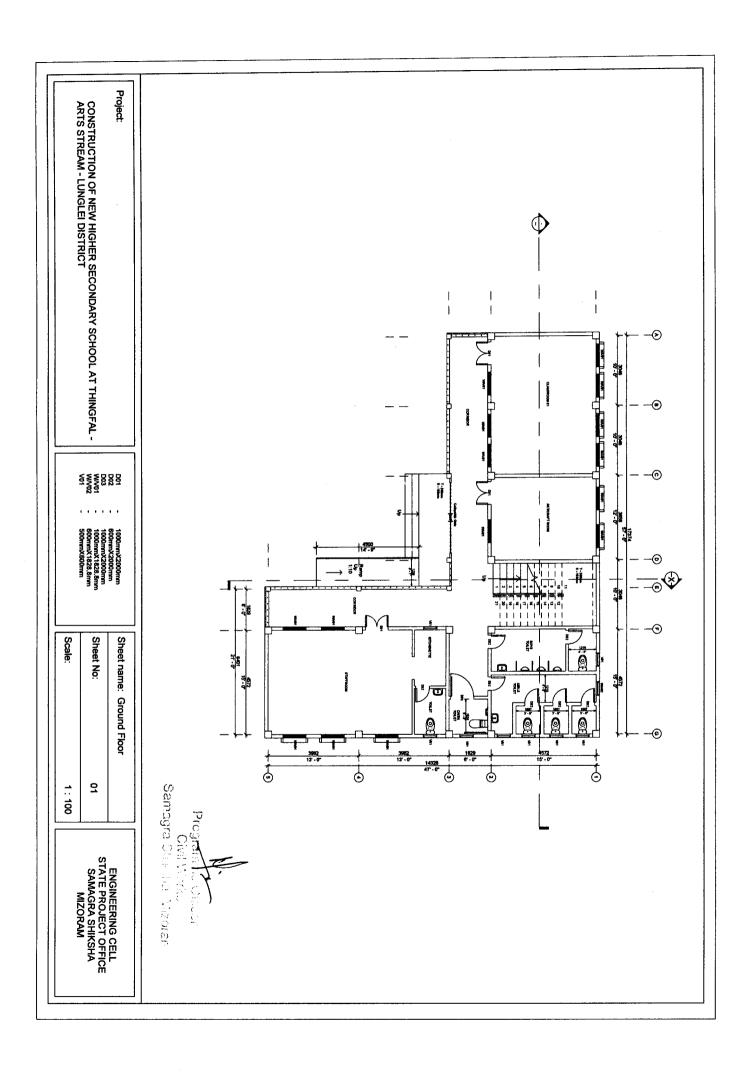

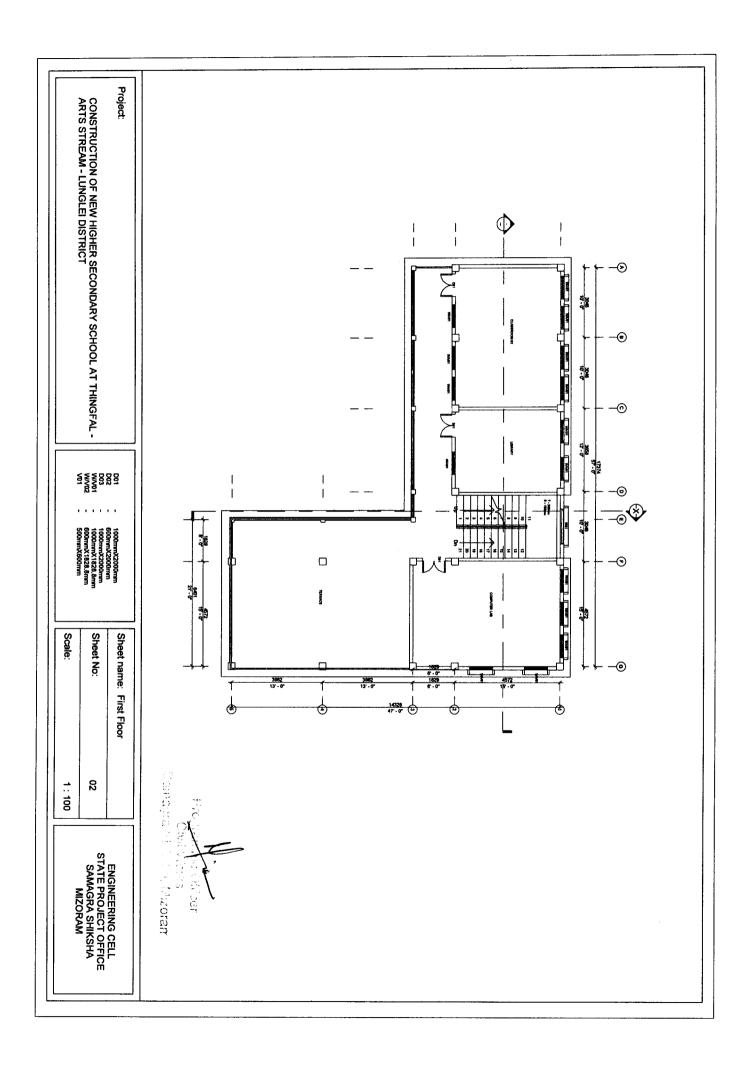

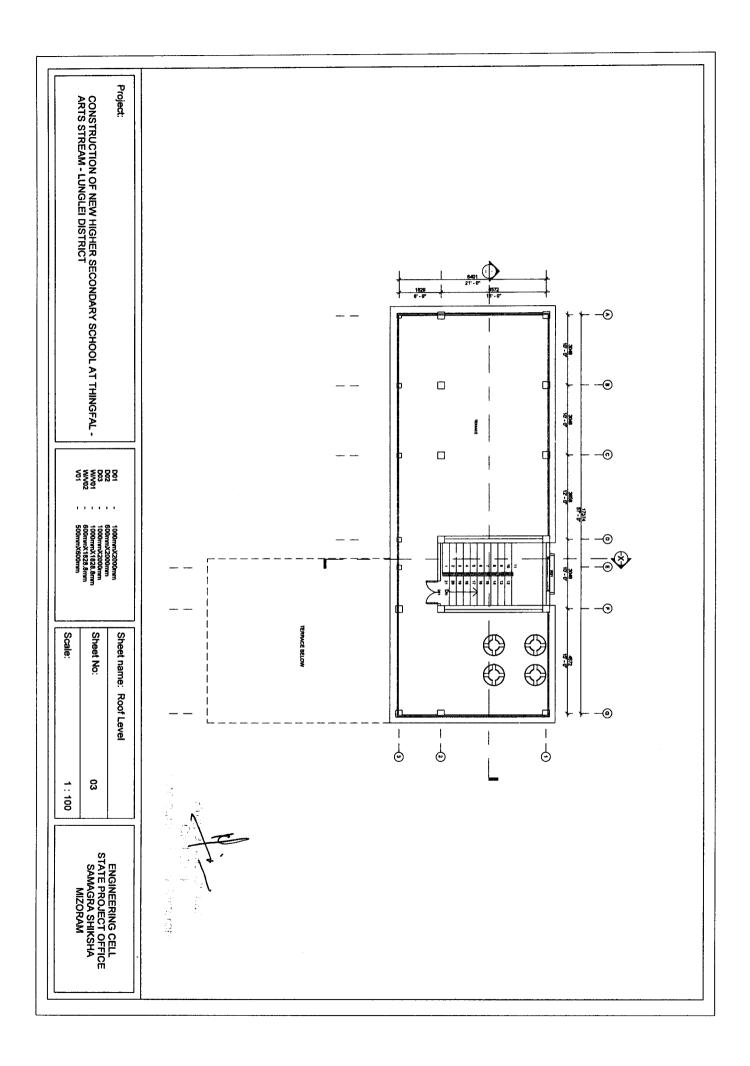


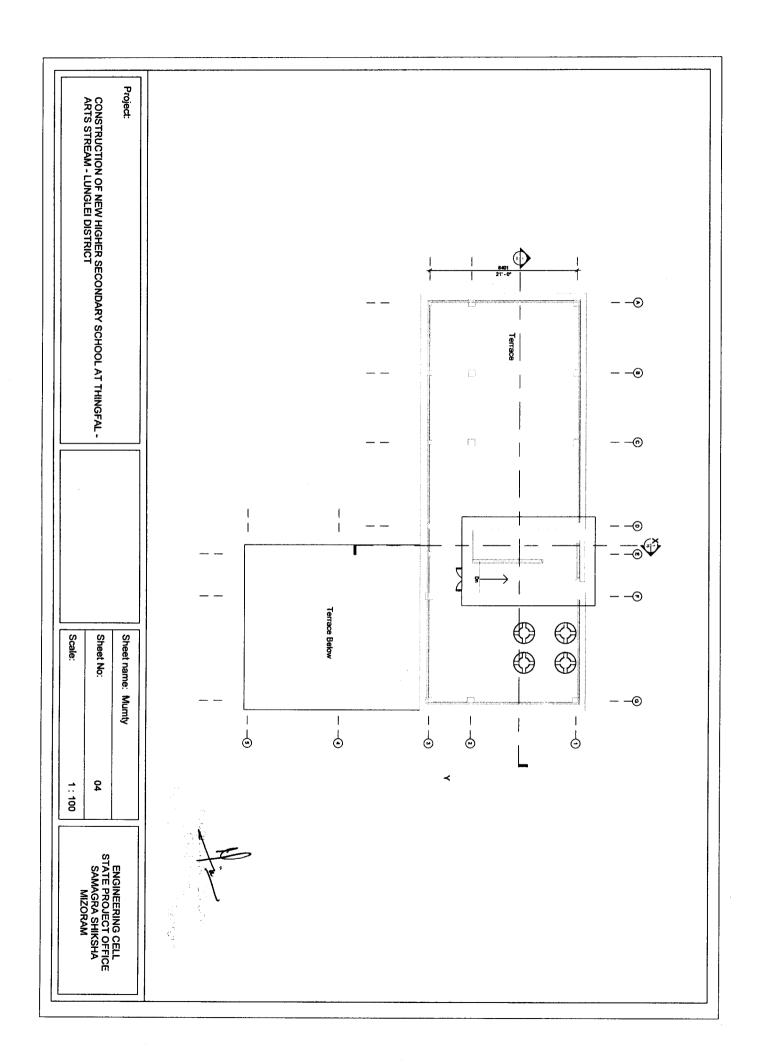

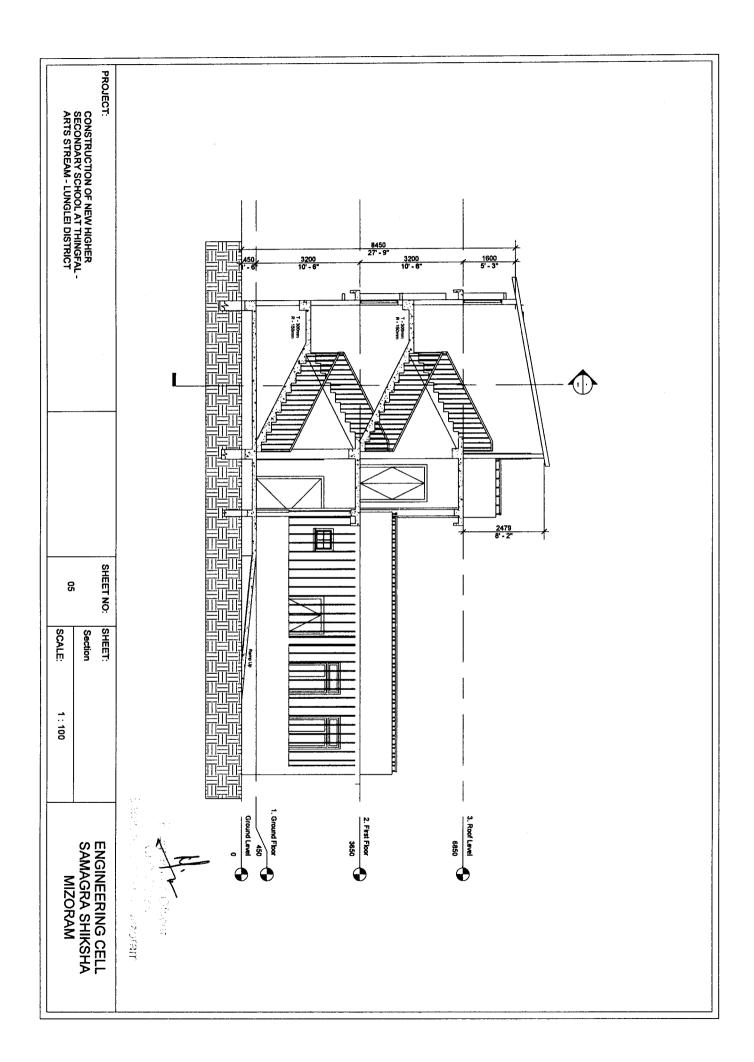

PROJECT: CONSTRUCTION OF NEW HIGHER SECONDARY SCHOOL AT THINGFAL-ARTS STREAM-LUNGLEI DISTRICT SHEET NO: 8 W 107 SHEET SCALE: Front View ENGINEERING CELL SAMAGRA SHIKSHA MIZORAM MANOL,

PROJECT: CONSTRUCTION OF NEW HIGHER SECONDARY SCHOOL AT THINGFAL - ARTS STREAM - LUNGLEI DISTRICT SHEET NO: 9 SHEET: SCALE: ENGINEERING CELL SAMAGRA SHIKSHA MIZORAM

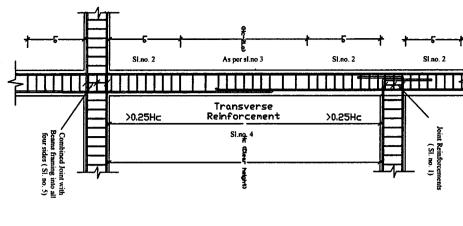

### NOTES:


- Joint which has beam framing into one/two sides shall be provided wih special confining steel with a spacing equal to Sl.No 2 within the joint
- 2. Special Confining Reinforcements shall be provided over a length 'Lo' from each joint face, twoards mid span and on either side of any section where flexural yielding may occur under the effect of earthquake forces. The length 'Lo' shall not be less than a). Larger lateral dimension of the member at the section where yielding occurs. b). 1/6 of the clear span of the member. c).


  450mm. The spacing of hoops used as special confining steel shall not exceed 1/4 of minimum member dimension but need not be less than 75mm nor more than 100mm.
- 3. The spacing of hoops within 'Hc-2Lo' shall not exceed half the least lateral dimension of the column, ecept where special confining reinforcements is provided for splice.
- Lap length shall be 69 thimes the diameter of longitudinal inforcements.
- 5. A Joint which has beams framing into all four faces shall be provided with a spacing double the special confining steel required at the end of the column. The spacing of the hoop within the hoint shall not exceed 150mm.
- Beam with higher reinforcement should be adopted at the point where two different types of beam meet.

Db = Bar diameter

Ld = Devlopment length in tension

LAP SPLICE IN BEAM

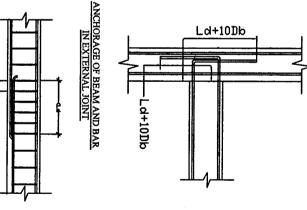

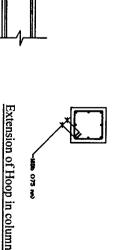


HOOK DETAILS



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Samagra Shiksha, Mizorum

Civil

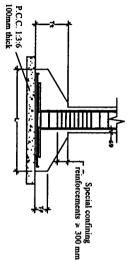


**FOUNDATION** 

Column and joint detailing


CONSTRUCTION OF THINGFAL HSS - ARTS


STREAM

SCALE : DRAWING
NO:
NO:
NO:
NO:
ALL DIMENSIONS ARE IN MM

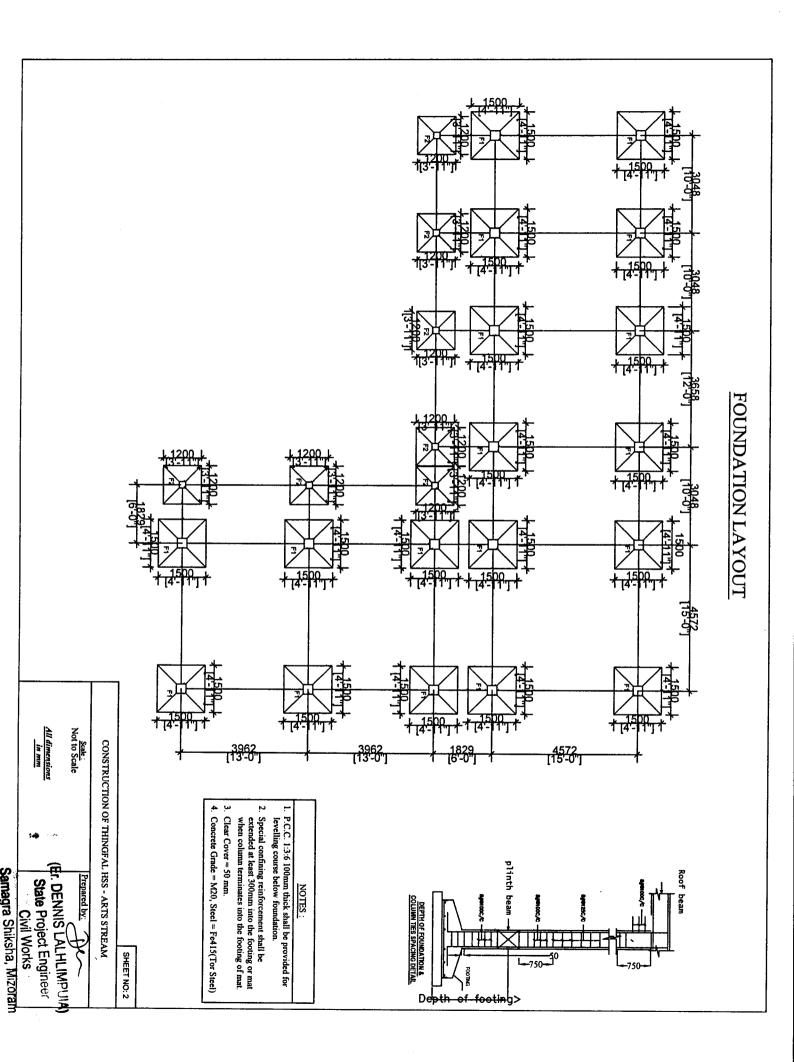

### FOUNDATION DETAILS

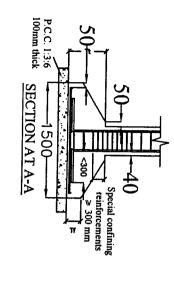

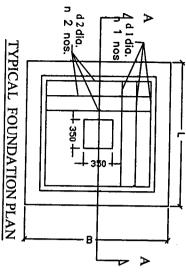

### NOTES:

- 1. P.C.C. 1:3:6 100mm thick shall be provided for levelling course below foundation.
- Special confining reinforcement shall be extended at least 300mm into the footing or mat when column terminates into the footing of mat.
- 3. Clear Cover = 50 mm.
- 4. Concrete Grade = M20, Steel = Fe415(Tor Steel)

_				<i>V</i>	•	A	•
F.2	3	¥ 1	<u> </u>		,	Type of Footing:	
1200 X 1200	1000 W 1000	1300 X 1300	1500 V 1500	LAD	I ~ D	Dimensions:	J
150		150				76	
300		300			-	₹	
12 mm		12 mm		d 1 dia.		L Dir	
12		15	7	n l nos		L Direction:	
12 mm		12 mm	7 in. 0.1	Dia do		B Direction	
12	1.0	15	11 2 1103.	n 2 ncc	POLICIA .	ction .	


CONSTRUCTION OF THINGFAL HSS - ARTS


SHEET NO: 3

STREAM


| Scale | Prepared by | Prepared by

Samagra Shiks. 3, M 2018

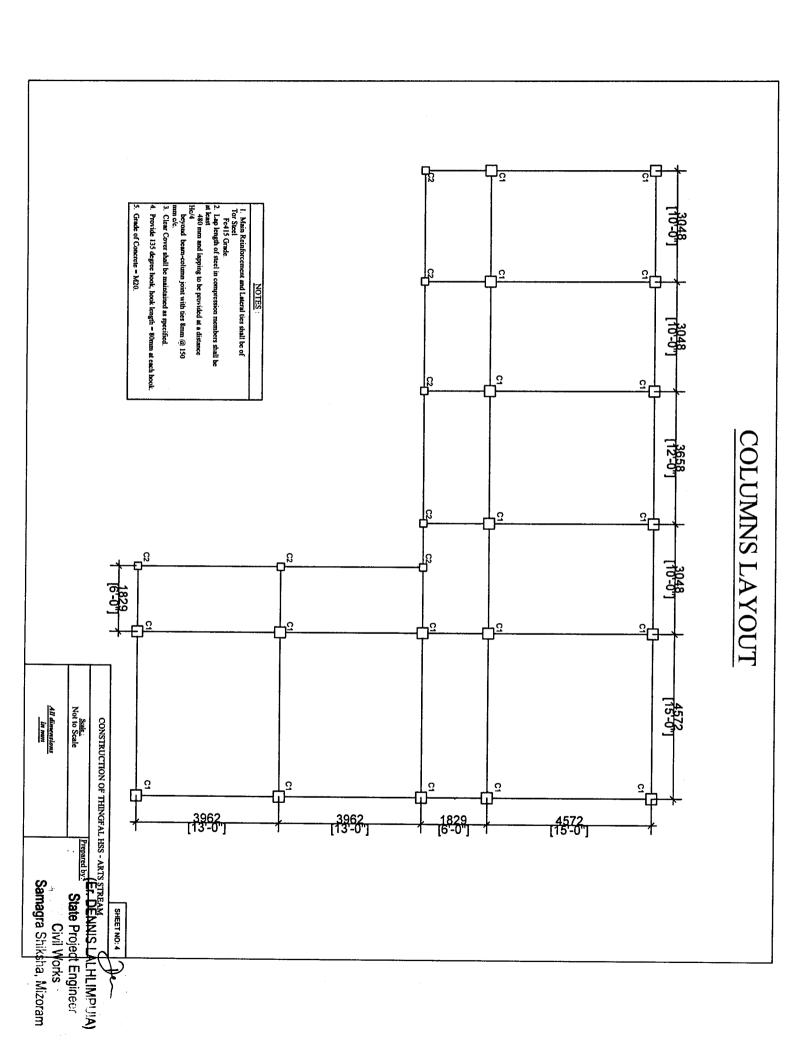


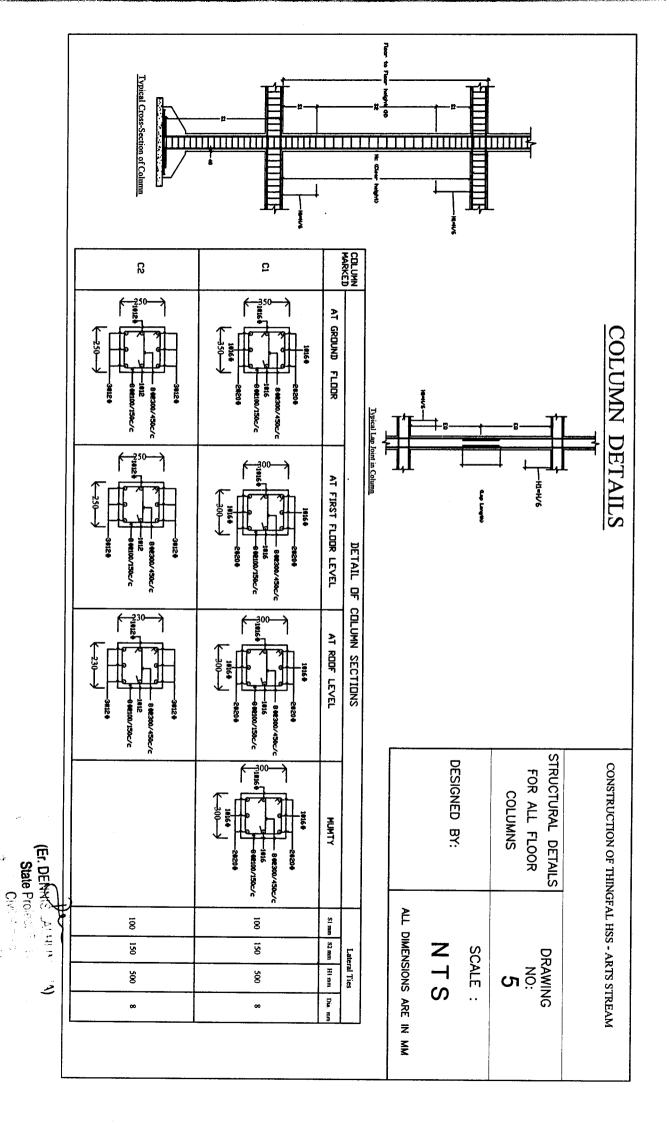

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# DETAILS OF MUMTY BEAM

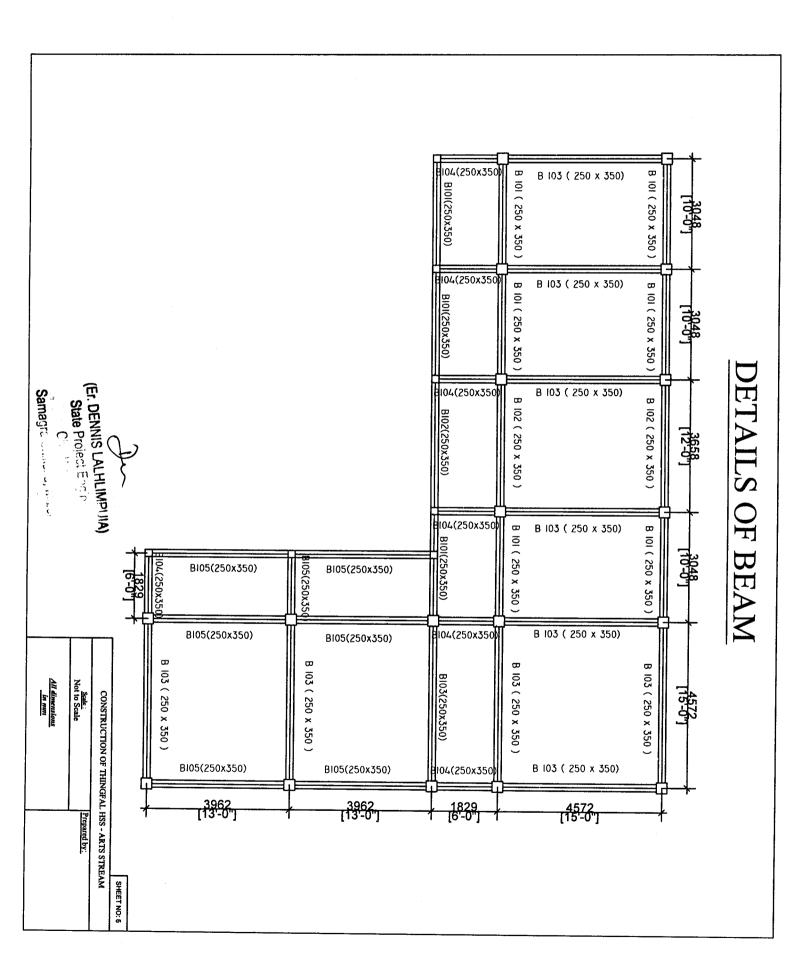

CONSTRUCTION OF THINGFAL HSS - ARTS STREAM

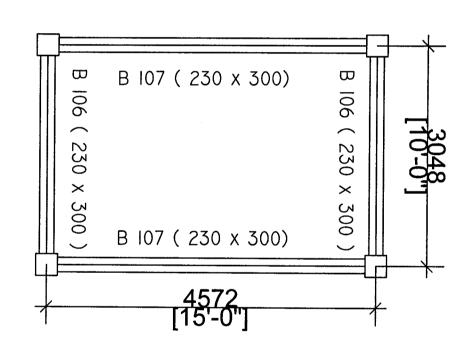SHEET NO: 7


Prepared by:

All dimensions in mm

Scale: Not to Scale

Samagra Sunday, Jil 201010

## TYPICAL LONG SECTION OF BEAM

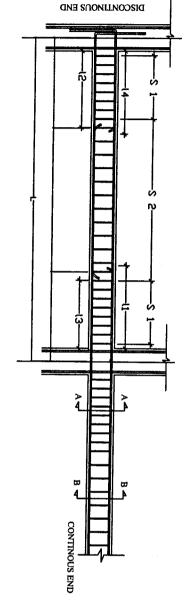



Ld = Devlopment length in tension
Db = Bar diameter LAP SPLICE IN BEAM

Where,

\$1 = Spacing of stirrups for a length of 2d

\$2 = Spacing of stirrups in the mid-span

Ld = development length of bar in tension

L = Length of beam (C/C of column)

B 107	B 106	B 103	B 104	B 103	B 102	B 101	Type of Beam
230 x 300	230 × 300	250 x 350	250 x 350	250 x 350	250 × 350	250 x 350	Dimensions : (mm)
3#10.	3#16+ EX	3#16+	3#16+	3M16.		3#14+	Section at A-A
2#16+	2#16.4	2#16+	350 2#16+	2816 +	2#16+	2#16.4	Section at B-B
4572	3048	3962	1829	4572	3658	3048	<u>}</u> -
1370	900	1150	550	1370	1100	900	(F) (F)
690	450	550	250	690	550	450	(ma) 1 22
1140	760	990	450	1140	900	760	(mm)
900	600	790	350	900	730	600	£ .
Some dia. Tor shori, 2 legged, 2 legged, 9 100 mm c/c	Tor dead, Tor dead, 2 legged, 6 No man of:	from dis. Ter sheel, 2 legged, 6 100 mm o'c	Same dia. Tor sheel, 2 legged, 5 100 mm c/c	Some dia Tor shed, Zieggod, g. 100 sam o'ç	Come dia Tor etcal 2 legged, 6 100 mm ofe	Tor sheet. 2 legged. 9 100 mm of	S 1
Rean dia Tor shei, 2 legged, 9 150 mm c/c	Terrison Torrison 2 legged e 150 mm c/c	Roum dix Tor steel, 2 legged, 8 150 mm e/c	Sum dia Tor steel 2 legged, g 150 mm &c	Ram dia Tor steel Lingged, 2 lingged, 9 150 mm c/c	Smen dia. Ter steel, 2 legged, 9 150 sam o'e	Soum dia. Tor sheet, 2 leggred, 8 150 dam of	S S

### SPECIFICATIONS :

- Clear Cover for Beam = 25mm
- Grade of Steel = Fe 415
- Grade of Concrete = M 20
- 4. The first hoop shall be at a distance not exceeding 50mm from the joint face.
- Minimum Curing Period = 28 days
- Beam with higher reinforcement should be adopted at the point where two different types


### (Er. DENNIS LALHLIMOTIA) State Project Engineer Civil Works


Samagra Shiksha, Mizoram


SHEET NO: 8


CONSTRUCTION OF THINGFAL HSS - ARTS STREAM

Certified that the requirements of Regulation 30 of the Aizawl Municipal Council Building regulations, 2012, have been complied with in the preparation of this structural drawing.

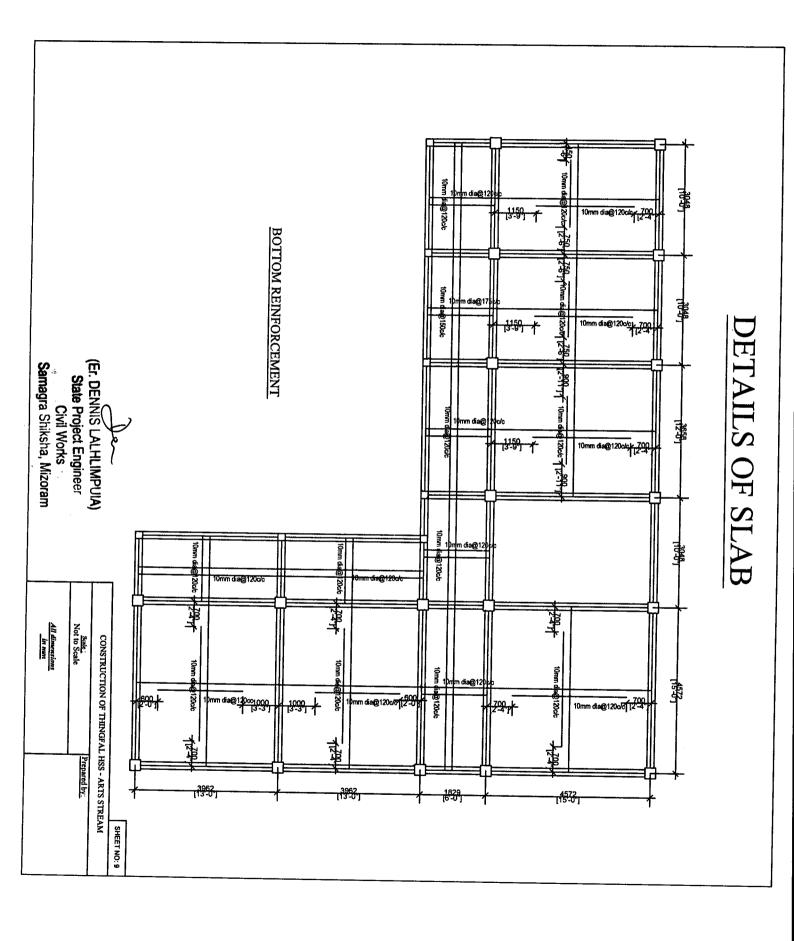

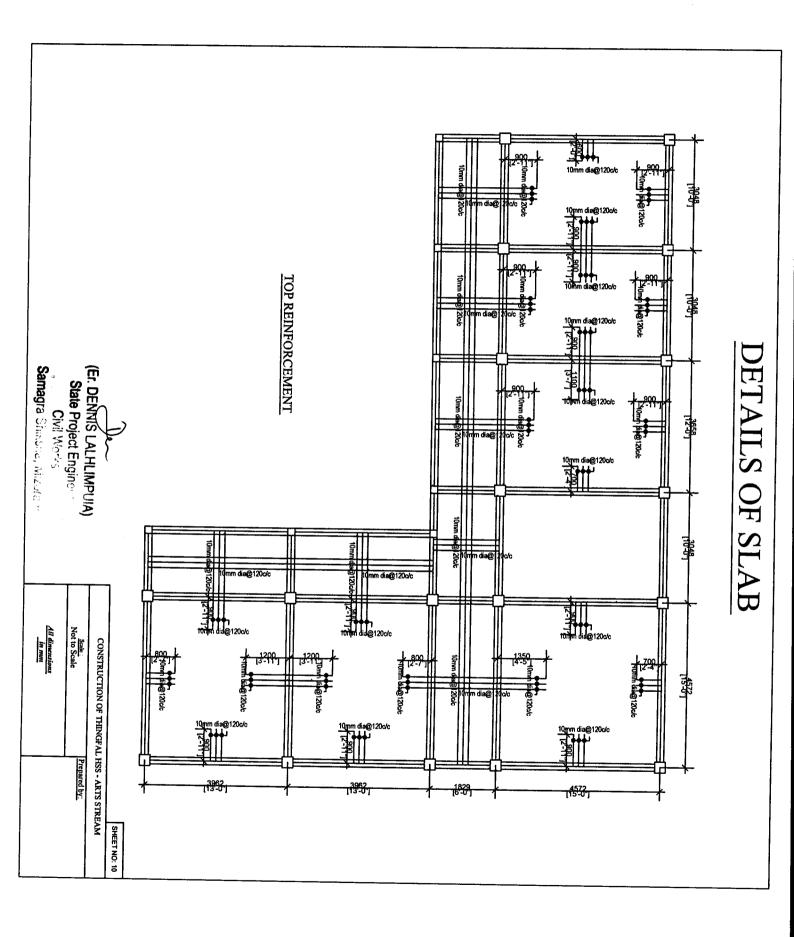

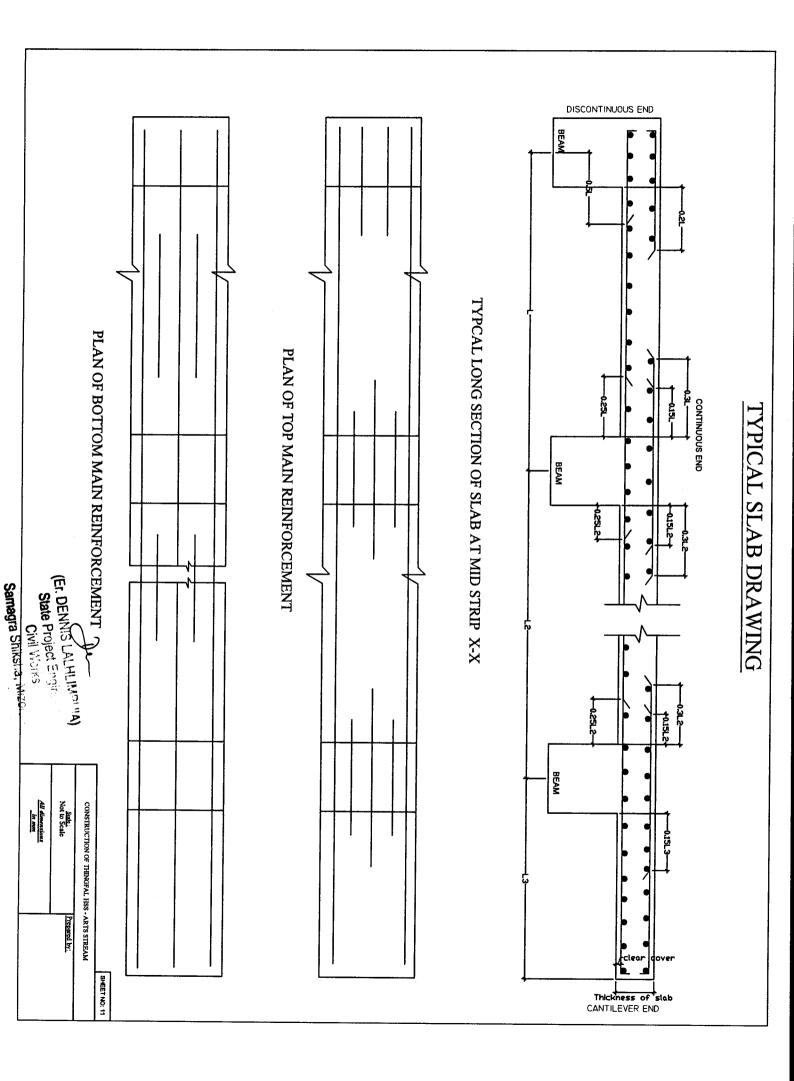

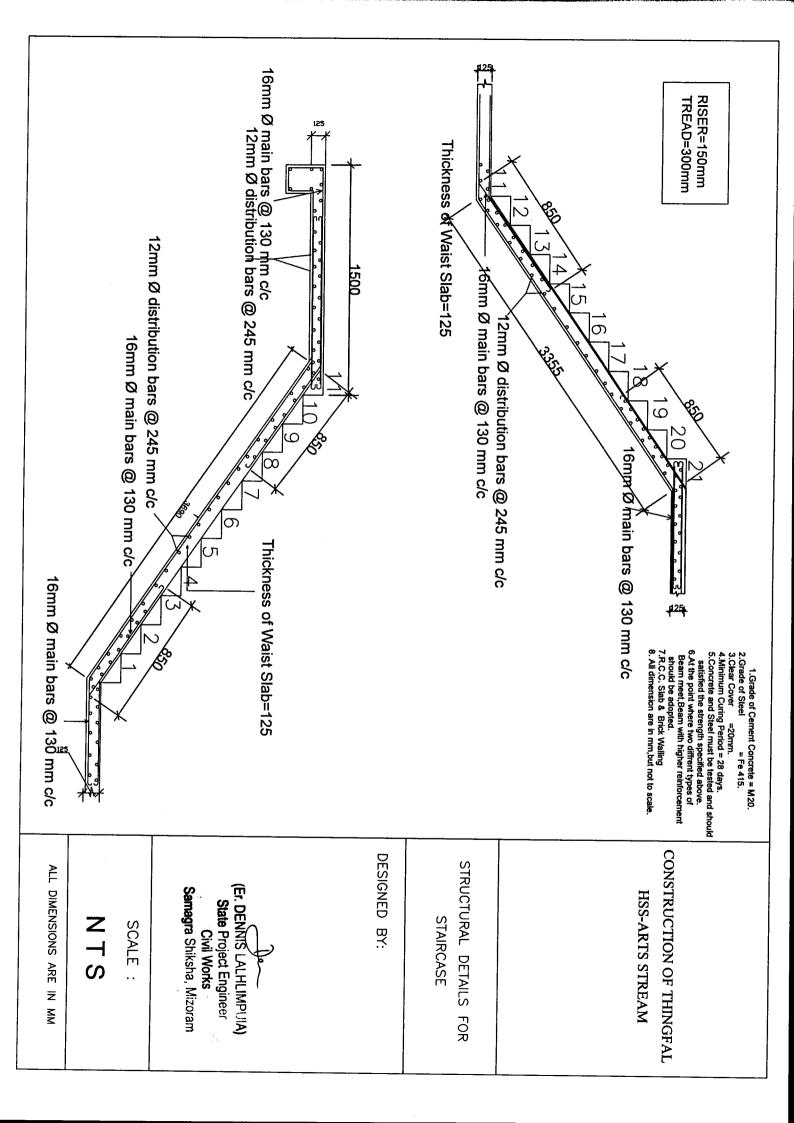

(A)	1 11 11 11		21.207	сит	(a) l:1.5:3 (1 cement : 1.5 coarse sand : 3 graded stone aggregate 20mm nominal size)	
					All work upto plinth level:	
					Providing and laying in position reinforced cement concrete excluding cost of centering and shuttering, finishing and reinforcement in -	5/5.01
			5.058	cum	b) aggregate 40mm nominal size)	
					Providing and laying in position cement concrete of specified grade excluding cost of centering and shuttering - All work upto plinth level:	4/4.03
			58.680	cum	2/3 of qty taken from 2/2.08	
					Filling available excavated earth (excluding rock) in trenches, plinth, sides of foundations etc. in layers not exceeding 20cm in depth, consolidating each deposited layer by ramming and watering, lead up to 50 m and lift upto 1.5 m.	3/2.17
			88.02	cum	(a) Oridinary Soil	
					Earthwork in excavation in foundation trenches etc. not exceeding 2 meters depth including dressing of bottom and sides of trenches and subsequent filling and compaction in 15cm layers as in column foundations, fence posts, etc. and disposal of all surplus soil as directed within a lead of 30 metres.	2/2.08
			231.800	cum	(a) Oridinary and Hard Soil	
					Earthwork in excavation over areas (exceeding 30cm in depth, 1.5m in width as well as 10sqm on plan) including disposal of excavated earth, lead upto 50m and lift upto 1.5m, disposed earth to be levelled and neatly dressed.	1/2.06
	in words	in figure	Vi3	CHIL		
Amount	Rate		.40	IInit	Description of Items	Sl.no
	ARTS STREAM)	THINGFAL HSS (	RUCTION OF	HE CONST	BILL OF QUANTITIES FOR THE CONSTRUCTION OF THINGFAL HSS (ARTS STREAM)	

(Er. DENNIS LALHLIM A)
State Project Engines
Civil Works
Samagra Shiksha, Mizoram

					T		9/5.10		8/5.18			7/5.03		6/5.02
e)	-	<u> </u>	$\downarrow$	1	_		<u> </u>				_			
Suspended floors, roofs, landings, shelves and their support, balconies and chajjaj,etc.	250x350	d) Lintels, beams, plinth beams, girders, bressumers and cantilevers, etc.		C2 250x250	C1 30X350	c) Columns, pillars, piers, abutments, posts and struts.	Centering and shuttering including strutting, propping, etc. and removal of form works in -	b) Thermo-Mechanically Treated Bars	Steel reinforcement for RCC work including straightening, cutting, bending, placing in position and binding all complete	a) aggregate 20mm nominal size)	-	Reinforced cement concrete work in beams, suspended floors, roofs having slope up to 15° landings, balconies, shelves, chajjas, lintels, bands, plain window sills, staircases and spiral stair cases above plinth level up to floor five level, excluding the cost of centering, shuttering, finishing and reinforcement complete.	a) aggregate 20mm nominal size)	Reinforced cement concrete work in walls including attached pillasters, columns, pillers, posts, piers, abutments, return walls, retaining walls, struts, buttresses, string or lacing courses, fillets etc. upto floor five level excluding cost of centering shuttering etc complete.
sqm	sqm		sqm	sqm	sqm			kg		cum			cum	ш.
475.67	241.800		231.26	63.26	168			22039.423		91.75			15.91	

(Er. DE State Samagre (Co. a, 1911)

15/20.08		14/11.02			13/11.01		12/9.10	11/9.06		10/6.06	
12mm cement plaster 1:4 (1 cement: 4 fine sand).	a) 4mm thick plate sheet glass.	Supplying of glass panes at site	(1)  2 - track sliding windows/ventilators.	(a) Natural Colour	Providing and fixing anodised aluminium work for doors, windows, ventilators and partitions with extruded built up standard sections/ other sections of approved make conforming to IS: 733 and IS: 1285 fixing with dash fasteners of required dia and size, including necessary filling up of gaps at junctions, at top, bottom and sides with required PVC/ neoprene gaskets etc. Aluminium sections shall be smooth, rust free, straight, mitred and jointed mechanically wherever required including cleat angle, aluminium snap beading for glazing /panelling, CP brass /stainless steel screws all complete including fixing of glasses but excluding cost of glasses.	a)  40 mm thick.	Providing and fixing 1st class teak wood <i>panelled</i> shutters for doors etc. including M.S. butt hinges with necessary screws, etc. complete.	Providing Ist class local wood dressed in frames of chaukat for doors, windows, clerestory windows fixed in position.	a) in cement moratar 1:3 (1 cement: 3 coarse sand)	Half brick masonry with first class brick in superstructure above plinth level upto floor V level.	f) Staircases (except spiral staircase) excluding landings.
sqm	sqm		sqm		,	sqm		cum	sqm		sqm
1884.49	60.12		60.12		24:14	24.40		0.763	465.980		20.39



	т-	<del></del>		<del></del>	1	1	7	
21/20.50		20/20.75		19/20.72	18/20.51		17/12.11	16/10.09
Applying one coat of water thinnable cement primer of approved brand and manufacture on wall surface:	a) Regular exterior emulsion like supercote, walmasta etc.	Finishing walls with exterior emulsion of required shade on new work (three or more coats) to give an even shade.	a) General quality	Painting with synthetic enamel paint of approved brand and manufacture in all shades on new work (two or more coats).	Applying priming coat with ready mixed pink or Grey primer of approved brand and manufacture on wood work (hard and soft wood) & Plywood.	b) Matt/Antiscratch	Providing and laying ceramic glazed floor tiles of size 300x300mm or more (thickness to be specified by the manufacturer) of 1st quality conforming to IS: 15622 of approved make in all colours, shades, except white, ivory, grey, fume red brown, laid on 20mm thick cement mortar 1: 4 (1cement: 4 course sand) including pointing the joints with white cement and matching pigments etc. complete. as per designed colour.	Supplying and fixing M.S. decorative railing consisting of top and bottom rails of 40mmx40mm square or circular section at distance of 788mm apart, 30mmx30mm square or circular section decorative intermediate balusters welded to top and bottom rails at 280mm apart. The base of balusters at 560mm apart welded with base plate of 60mmx3mm thick and fixed with cement grouting firmly to concrete section including steel priming ans steel painting complete etc.
sqm	sqm		sqm		sqm	sqm		sqm
1884.49	1884.49		71.700		71.70	86.81		16.10

(Er. DENNIS \_ALHLIM 'IA)
State Project Engine ...
Civil Works
Samagra Shiksha, Mizoram

		29/17.35		28/17.34		27/17.33						26/18.01		25/14.10			24/14.07		23/14.11		22/7.01
	a)   110 mm dia	Providing and fixing SWRPVC plain bend of required degree (45°) including jointing with rubber lubricant/cement solvent complete.	a) 110 mm dia.	Providing and fixing SWRPVC plain bend of required degree (87.50°) including jointing with rubber lubricant/cement solvent complete.	a) 110mm dia.	Providing and fixing on wall face SWRPVC soil, waste and vent pipes including jointing with rubber lubricant/cement solvent complete.	a) Sintex or quivalent	connections for inlet, outlet and overflow pipes but without the cost for base support.	suitable locking arrangement and making nescessary	manufacture with cover and mosquito proof coupling and	Polyethylene storage tank of approved brand and	Providing and fixing on terrace (at all floor levels)	(a) 150mm	Providing and fixing M.S. handles with necessary screws, etc. complete	c) 200 mm	(a) 300 mm	Providing and fixing M.S. Tower bolts (socket bolts) bright finished with necessary screws etc. complete.	a) Union type	Providing and fixing bright finished M.S two lever mortise door lock with necessary screws, etc. complete.	C) in cement mortar 1:6 (lcement:6 fine sand)	Regular coursed rubble masonry with hard stone in foundation upto one storey above and below ground level including curing, etc. complete.
2408	N.S.		Nos		m		lit						Nos		Nos	Nos		Nos		cum	
20	30		15		45.00		4000.00						32.00		7	7		7		3.47	
		>																			

(Er. DENNIS LALHLING MA)
State Project Engine
Civil Noors
Samagra Shiksira, ilizurum

}				complete (New work).	
	<b>)</b>			cutting and threading the pipe and making long screws etc.	
				Froviding and fixing G.I. Union in G.I. pipe including	3//18.09
		12	Nos	b) 20mm nominal bore	
				Providing and fixing brass bib cock of approved quality.	36/18.07
		30.00	rm	a)  20mm dia nominal bore	
				clamps, including cutting and making good the walls etc.  (internal works- exposed on wall).	35/18.02
		3	Nos	(i) White	
					34/17.14
		ω	Nos	(i) White	
				equivalent make with flush valve/spray with C.I or R.S brackets standard size of G.I flush pipe and C.P brass spreaders with brass unions and G.I clamps complete including painting of fittings and brackets, cutting and making good the walls and floors wherever required.	33/17.11
				Providing and fixing vitreous china Urinal Flat Back Small	-
		6	Nos	(i) White	
·				Providing and fixing vitreous china pedestal type water closet (European type W.C. pan) with seat and lid, 10 litre low level white P.V.C. flushing cistern, including flush pipe, with manually controlled device (handle lever), conforming to IS: 7231, with all fittings and fixtures complete, including cutting and making good the walls and floors wherever required:	32/17.04
		6	Nos	a)   110 mm dia.	
				Providing and fixing ventilation cowl including jointing with rubber lubricant/cement solvent complete.	31/17.42
		15	Nos	a)  110x110x110 mm	
				Providing and fixing single equal SWRPVC plain junction of required degree ( T-junction ).	30/17.37

(Er. DENNAS LALHLING IA)
State Project Enginec.
Civil Works
Samagra Shiksha, Mizoram

	1/2.08		41/10.04	40/17.24	39/10.18			38/17.16	
(a) Oridinary Soil	Earthwork in excavation in foundation trenches etc. not exceeding 2 meters depth including dressing of bottom and sides of trenches and subsequent filling and compaction in 15cm layers as in column foundations, fence posts, etc. and disposal of all surplus soil as directed within a lead of 30 metres.	SEPTIC TANK	Providing and fixing in position collapsible steel shutters with vertical channels 20x10x2mm and braced with flat iron diagonals 20x5mm size with top and bottom rails of T-iron 40x40x6mm with 40mm dia. steel pulleys complete with bolts, nuts, locking arrangement, stoppers, handles, including applying a priming coat of approved steel primer.	Providing and fixing mirror of superior glass (of approved quality) and of required shape and size with plastic moulded frame of approved make and shade with 6 mm thick hard board backing:	Providing and fixing M.S. grills of required pattern in frames of windows etc. with M.S. flats, square or round bars etc. including priming coat with approved steel primer all complete.	i) white	a) Vitreous China Wash basin size 630x450 mm with single 15 mm C.P. brass pillar taps	Providing and fixing White vitreous china wash basin Standard of Parryware/ Hindware/ Cera and equivalent make with R.S. or C.I. brackets, 15mm C.P. brass pillar taps, C.P. brass chain with rubber plugs, 32mm C.P. brass waste of standard pattern, 32mm C.P. brass traps and union complete including painting of fittings and brackets, cutting and making good the walls wherever required.	b) 20 mm nominal bore
m³			mps	Nos	sqm	Nos			Nos
6.000			6.00	ω	88.70	3			20

(Er. DENNIS LALHLIMPUIA)
State Project Engineer
Civil Works
Samagra Shiksha, Mizoram

Crond Total
Add 34.55 % C.I for Lunglei District



## BILL OF QUANTITIES NAME OF WORK : ELECTRIFICATION OF THINGFAL HSS ; LUNGLEI DISTRICT

SOR	DESCRIPTION OF MATERIAL	UNIT	QUANTITY	in figure	RATE
C:02:00	SURFACE PVC CASING &CAPPING COPPER WIRING ( GRADE-II)			9	
	LIGHT POINT, CEILING FAN POINT, EXHAUST FAN POINT ETC (MODULAR TYPE)				
	Wiring in looping system with PVC wire sheathed standard				
	copper conductor/wires as per IS:694 (1990) and Flame				
	retardant low smoke & Halogen (FR-LSH)1100 voltage graded				
	copper flexible wire stranded copper running inside PVC casing				
	& capping (Gr-II) 20mm dia fixed, surface on the				
C:02:01	C:02:01   wall/ceiling/floor as per convenience including junction box				
	having required numbers of ways from control switch to the				
	light point etc as required:-				
	LIGHT POINT				
	C:02:01 (C) Medium Point (Modular)	Each	22		
	C:02:01 (D) Long Point (Modular)	Each	15		
	FAN POINT				
	C:02:01 (C) Medium Point (Modular)	Each	9		
	LIGHT PLUG/SOCKET POINT 5/6 AMPERES (MODULAR TYPE)				
	Wiring in looping system with PVC wire sheathed standard				
	copper conductor/wires as perlS:694 (1990) and Flame retardant				
	low smoke & Halogen (FR-LSH)1100 voltage graded				
C:02:02	copperflexible wire stranded copper running inside PVC casing &				
	capping (Gr-II) 20x12mm fixed, surface onthe wall/ceiling /floor				
	as per convenience including junction box having required		<del></del>		
	numbers of ways fromDB to the light plug/socket 5/6A point etc.				
	as required :-				
	C:02:02(E) Light plug Point Very Long Point (modular)	Each	7		



							1:02:00														C:02:06												C:02:03				
I:02:158 3 S + 1SOC +1R+ 1BKP	Eight modules Switch Board (Modular)	1:02:86 2 S + 1 R + 1SOC	Six modules Switch Board (Modular)	1:02:13 2 S	Two modules Switch Board (Modular)	1:02:03 1 S two ways	1:02:01 1 S	One Module Switch Board (Modular)	fan regulators etc. with necessary painting if necessary	boxes, modular plate and necessary switches, plug/socket, and	following sizes/modules on surface/recess including PVC/Steel	Supplying and fixing of Modular switch board grade-II of the	grade-II	SUPPLYING AND FIXING OF SWITCH BOARDS ( MODULAR TYPE )	earth wire	C:02:06(B) 2X4 Sqmm copper conductor/cable + 1x4 Sqmm	earth wire	boards as required:-	Main/DB/Sub-Main/DB to SDB/SDB/Switch boards/SDB to switch	junction box having required numbers of ways from Main to Sub-	surface on the wall/ceiling/floor as per convenience including	& capping (Grade-II) of all available sizes diameter fixed,	copper flexible wire stranded copper running inside PVC Casing	retardant low smoke & Halogen (FR-LSH) 1100 voltage graded	copper conductor/wires as per IS:694 (1990) and Flame	Wiring in looping system with PVC wire sheathed standard	(SINGLE PHASE TWO WIRES)	MAIN TO SUB-MAIN IN COPPER WIRE GRADE-II SURFACE	C:02:03(E) Power plug Point 15/16 A Very LongPoint (modular)	point etc. as required :-	numbers of ways from DB to the power plug/socket 15/16A	/floor as per convenience including junction box having required	capping (Gr-II) 30x12mm fixed, surface on the wall/ceiling	fexible wire stranded copper running inside PVC casing &	low smoke & Halogen (FR-LSH)1100 voltage graded copper	copper conductor/wires as perIS:694 1990) and Flame retardant	TYPE)Wiring in looping system with PVC wire sheathed standard
No		No		No		No	No								3		3												Each								
6		3		2		3	6								50		310												ы								
State Project	(Er. DENNIO THE POO	III) I HLIMPUIA	4																																		


					J:01:00				J:00:00		0:03:00	0:00:00		N:01:00	N:00:00
Q:01:07 Earthing with Copper Earth plate 600mmx600mmx6mm thick including accessories and providing masonery enclosure with cover plate having locking arrangment and water pipe, etc. (but without charcoal or coke and salt ) complete as required.	(Usha/Crompton/Equivalent)	(1845)Ceilling fan 1200mm Sweeps ISI marked 3 blades	J:01:36 Installation, testing & commissioning of ceiling fan and regulator, including wiring the down rod of standard length (upto 30cm) with 2X1.5 sqmm PVC insulated copper conductor single core cable etc, as required	(1377) LED Batten fitting 1x26W Linea'4 with LED tube (Phillips/equivalent)	(1375) LED Batten fitting 1x12W Linea'2 with LED tube (Phillips/equivalent)	J:01:30 Installation, testing & commissioning of pre-wired flourescent Light fittings of all types, with all accessories and tubes etc, directly on ceiling/wall, including connection with 1.5 Sqmm copper conductor single core cable etc as required.	(1661) CFL Curvy 15W(SP ) B22,E27 Base Havells/Equivalent	J:01:03 Supplying, fitting and fixing Batten Holder including connection etc. as required	LIGHTING FIXTURES(SURFACE/RECESS)	etc, as required.  O:03:75 6-ways MCB DB SP & N DD metallic Door	MCB DISTRIBUTION BOARD Supplying, fitting, & fixing of 63 amps' 6-Ways Distribution Board with Bakelite fused fitting with fused links, 240 Volts 50 Hz AC on surface/recess completed including inter-connection, painting	DISTRIBUTION BOARDS	N:01:26 40 Amps' DP, MCB Isolator	MCBs SP/SP&N/DP/TP/TP&N/FP  Supplying and fixing of all types and rating MCBs, RCCBs, ELCBs etc, 240/415 Volts 50 Hz AC supply in the existing MCB DB complete with connections, testing & commissioning etc in N:01:01 5 to 32 Amps ,SP, MCB B- series	MCBs/RCCBs/ELCBs/MCCBs/EARTH FAULT RELAY SP/SPN/DP/DP&N/TP/TP&N/FP
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												R:01:00						:			-			-		C. 01.00		
GRAND TOTAL	Add 1% Labour Cess	Add 18% GST	Total	Aluminium cable Lump sum	Single phase service connection 16sqmm twin core	from earth electrode directly in ground as required.	P.O1:67Providing and laving of connertane 32mmy6mm thick	(DOKCINI/Equivalent) in complete	with base plate to mount lightning Arrestor	lightning Arrestor 50m 3 meters long made of SS-304 material	R:01:10Providing and fixing of Stainless steel pole for ESE	micro second delay (DOKSUN/equivalent)	area of 63m diameter lightning charge capacity 100 KA and 43	Duly tested and certified by CPRI Bangalore, Having coverage	standardized according to norms UNE 21.186 AND NPC 17.102	6.5 (DPDC 6.5) with non electric ESE(Early steamer Emission)	R:01:08Providing and fixing of ESE type lightning Arrestor PDC	LIGHTNING CONDUCTOR	alongwith others wires as required.	surface/recess steel/PVC conduit/PVC cassing & capping	copper conductor for loop earthing in the existing	Q:01:55 Supplying and drawing of 1.5 sqmm PVC sheathed	dia'))	including soldering etc. as required. (8 SWG Copper Wire (4mm	.50mbelow ground level for conductor earth electrode,	Q:01:38 Supplying & Laying of 8 SWG Copper Wire at	earth electrode as required.	Q:01:10 Extra for using salt and coke for G.I or copper plate
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(Er. R. LALNUNFELA)
Programme Officer
Civil works
Samagra Shiksha, Mizorar

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(Er. DENNIS LALHLIMA State Project Engineer Civil Works
Samagra Shiksha, Mizoram



LED Batten fitting 1 x 20W
4' with LED tube

LED Batten fitting 1 x 12W 2' with LED tube

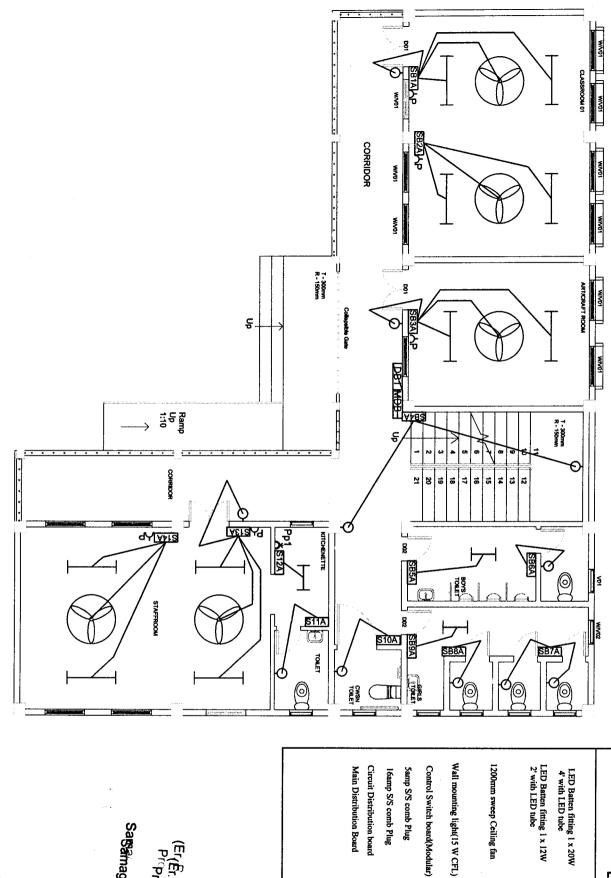Wall mounting light(15 W CFL)

5amp S/S comb Plug

16amp S/S comb Plug

Main Distribution Board Circuit Distribution board

0

SHEET NO: I

**LEGENDS** 


Samagra Shiksha, Mizoram State Project Eng - -Civil Works

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Programme Officer
Civil works




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(Er DENNIS LALHLIS, A)
State Project Engine
Civil Works
Civil Works
Samagra Shiksha, Mizoram

4 sq.mm two core copper cable (ISI) 1.640KW Z 6-way MCB DB SP & N D/D MCB DP 40 A (ISOLATOR) MCB 10A MCB 10A MCB 10A MCB 16A 2.5 sqmm cu. cable 2.5 sqmm cu. cable 2.5 sqmm cu. cable Switch (SB1B - SB5B) 5/6 A Plug (P1 - P7) SPARE SPARE SCALE: NOT TO SCALE DATE: 05/06/2024 DRAWING: SINGLE LINE DIAGRAM NOTES PROJECT STATE PROJECT OFFICE SAMAGRA SHIKSHA, MIZORAM THINGFAL HSS (ART'S STREAM)
AT LUNGLEI DISTRICT COUNTERSIGNED BY DRAWN BY SHEET NO: 04

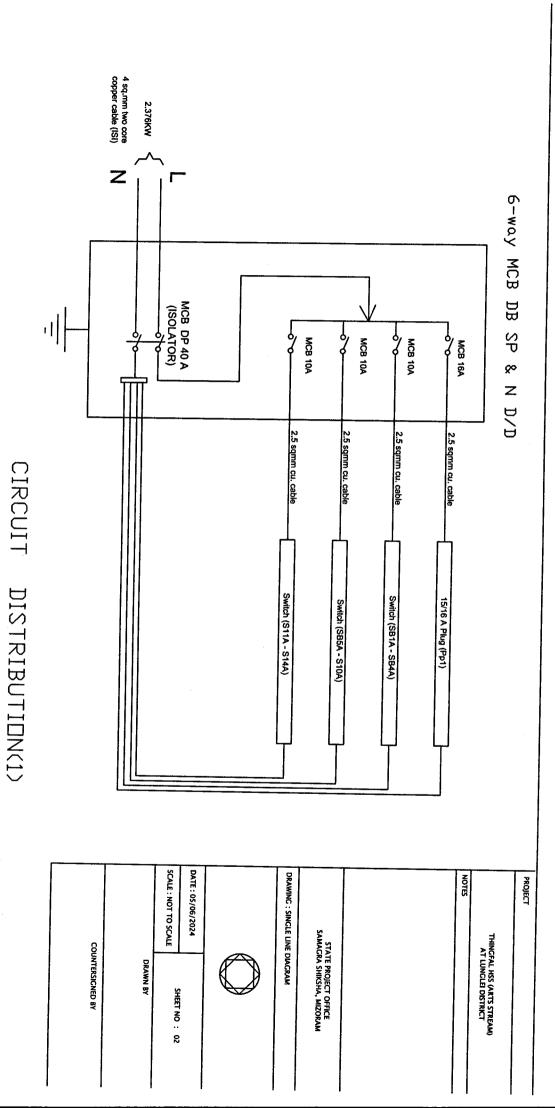Samagra Shiksha, M.

Civil works

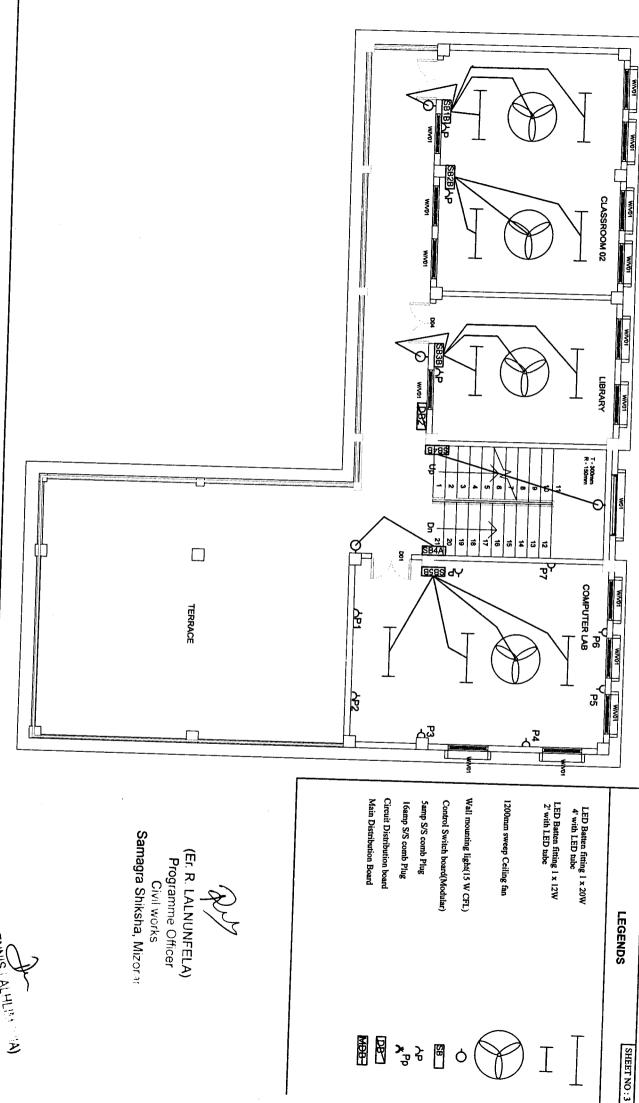(Er. R. LÁLNUNFELA) Programme Officer

CIRCUIT DISTRIBUTION(2)

(Er. DENNIS LALHLIMPUIA)
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