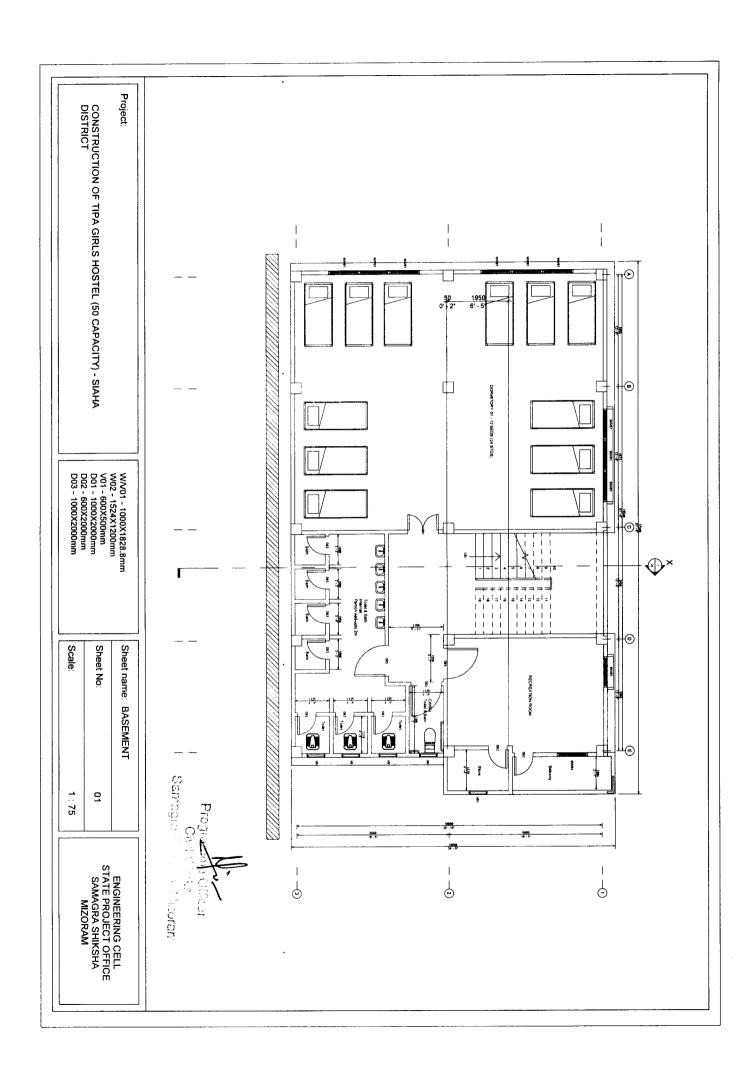
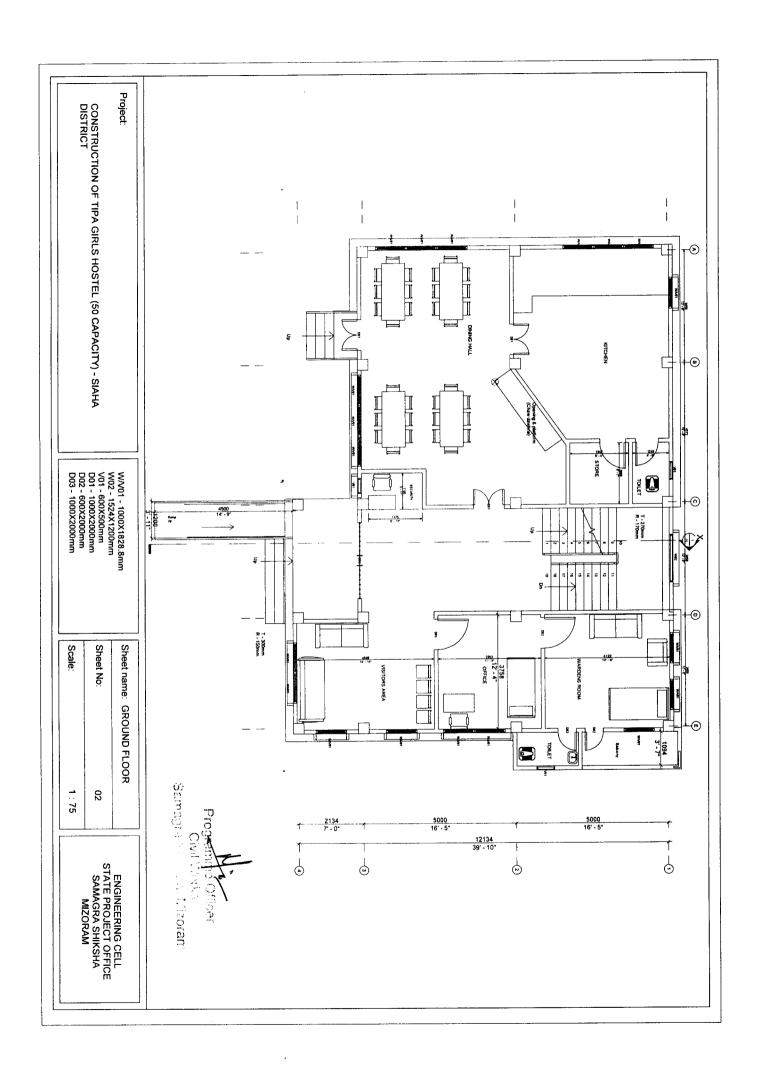
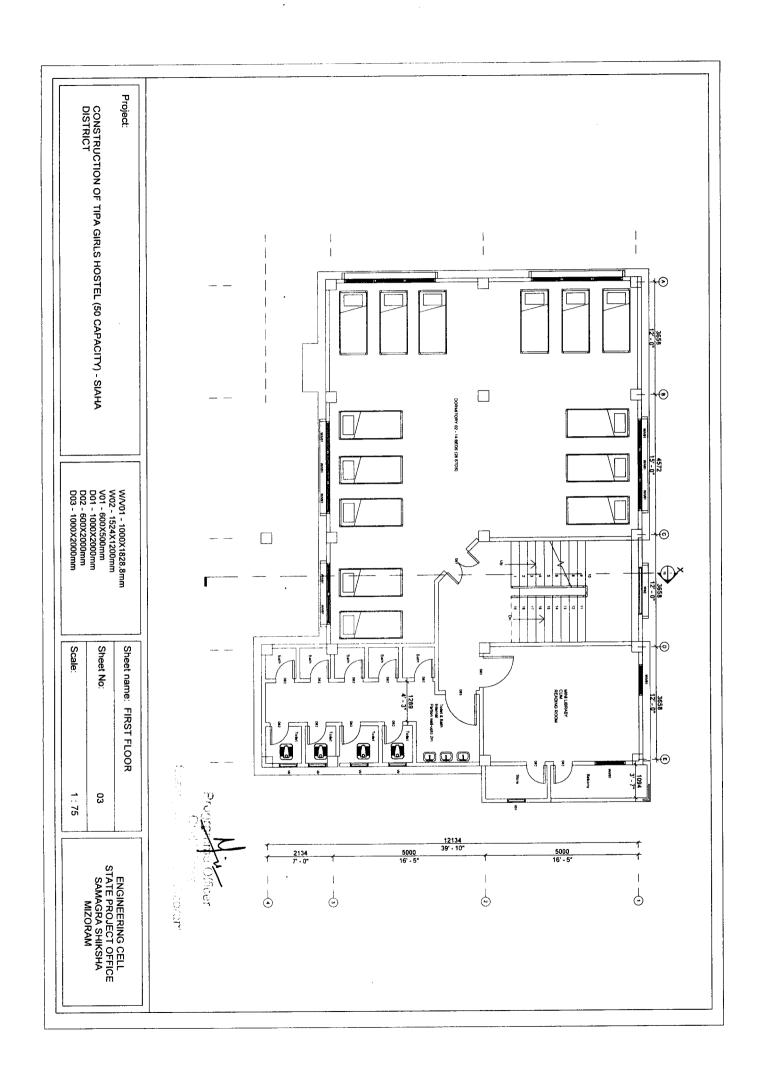
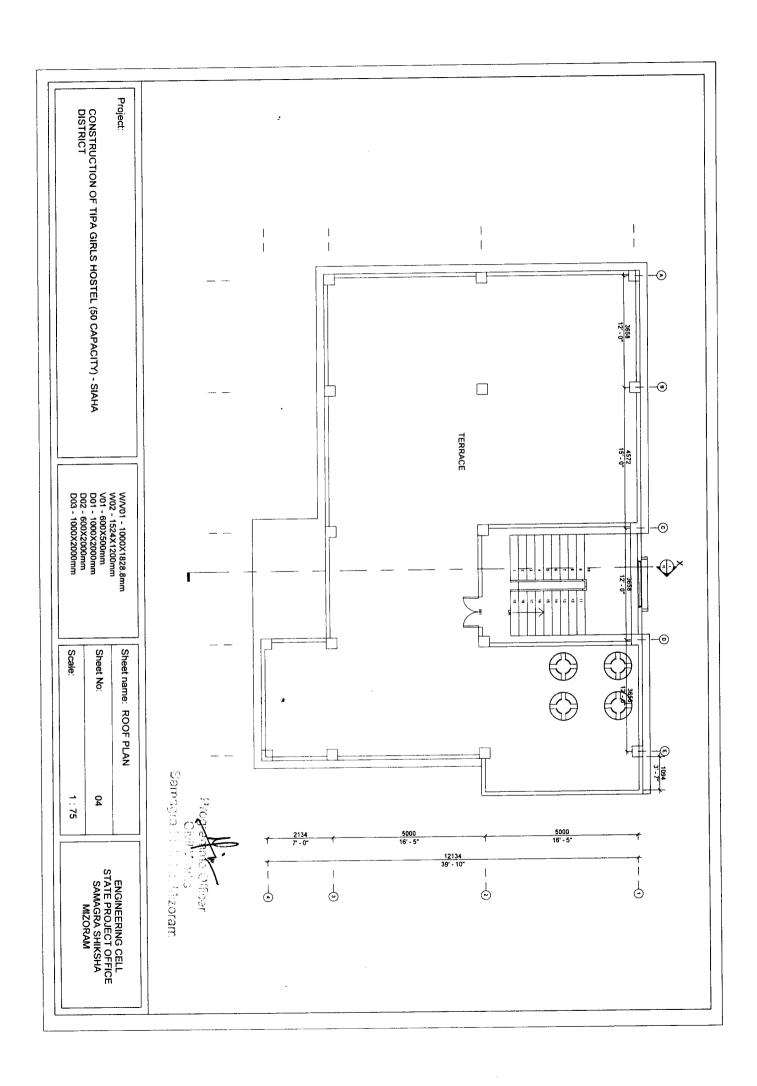
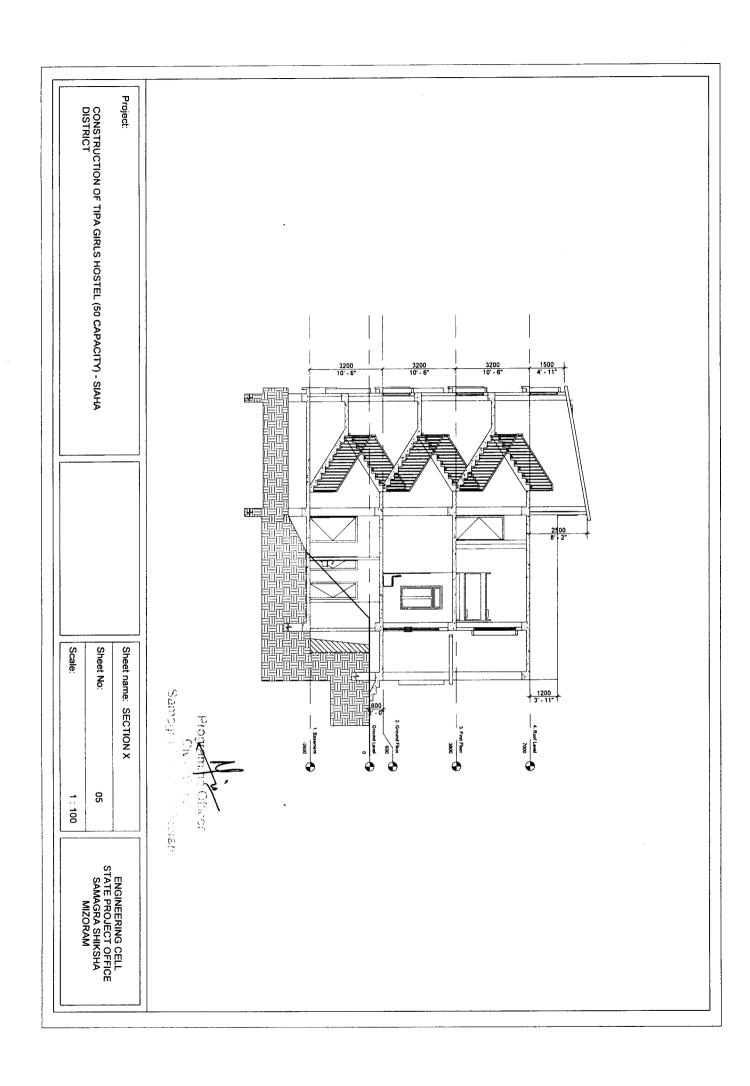
CONSTRUCTION OF TIPA GIRLS HOSTEL (50 Capacity) AT SIAHA DISTRICT

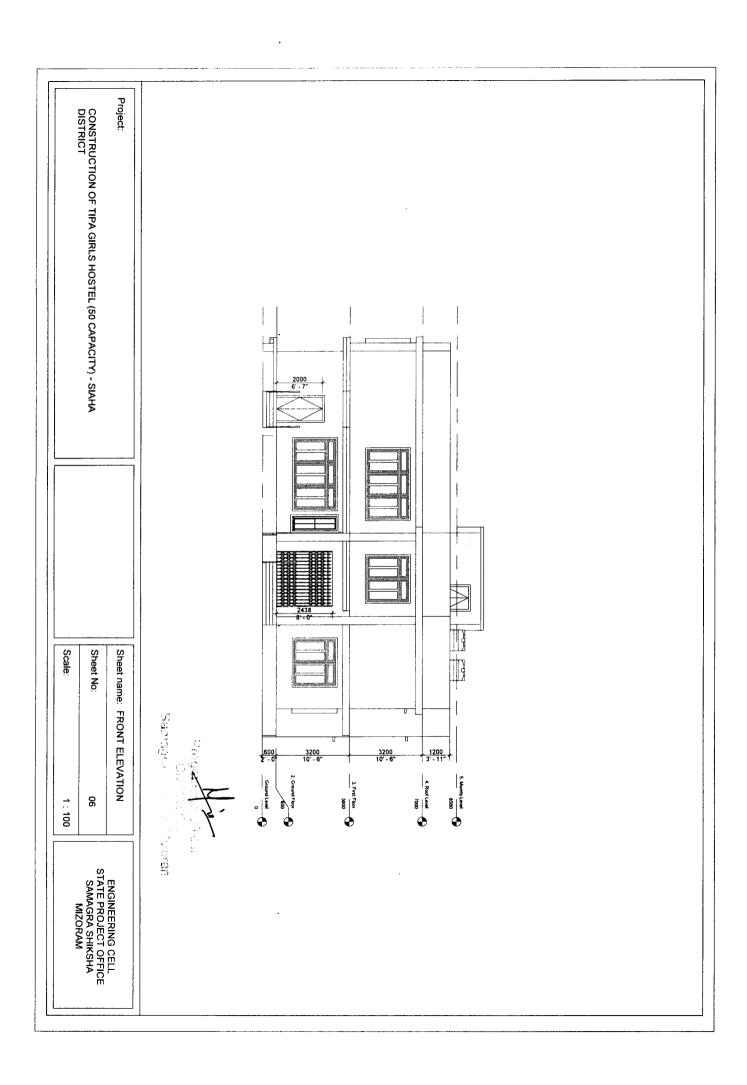


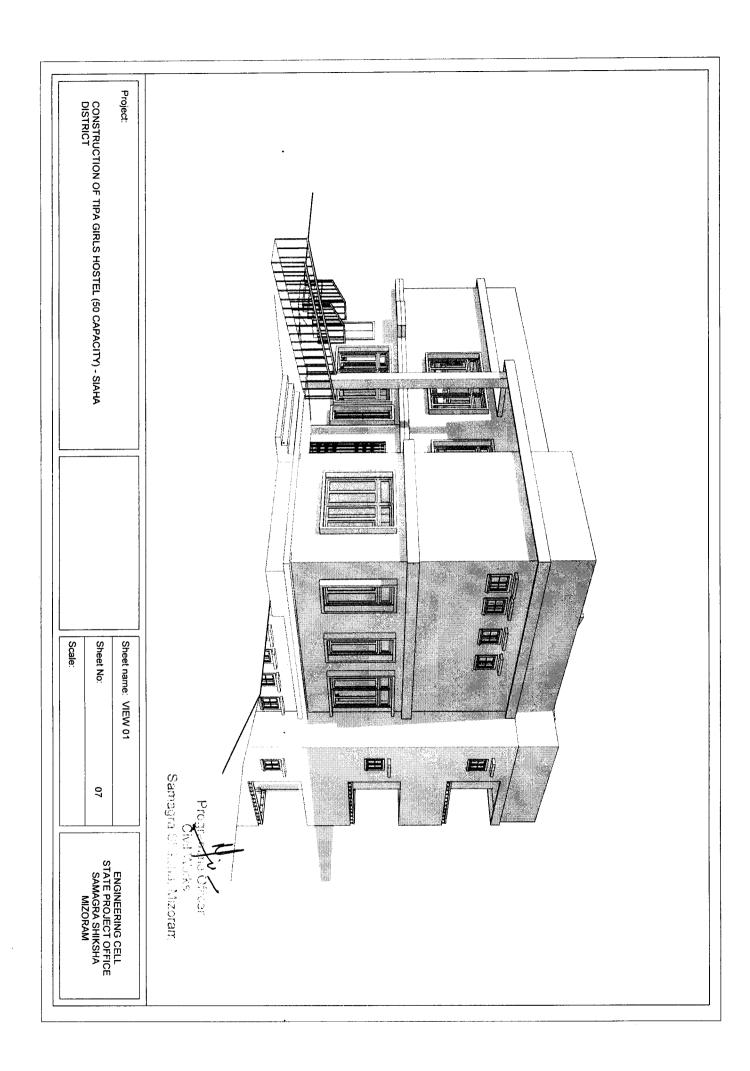


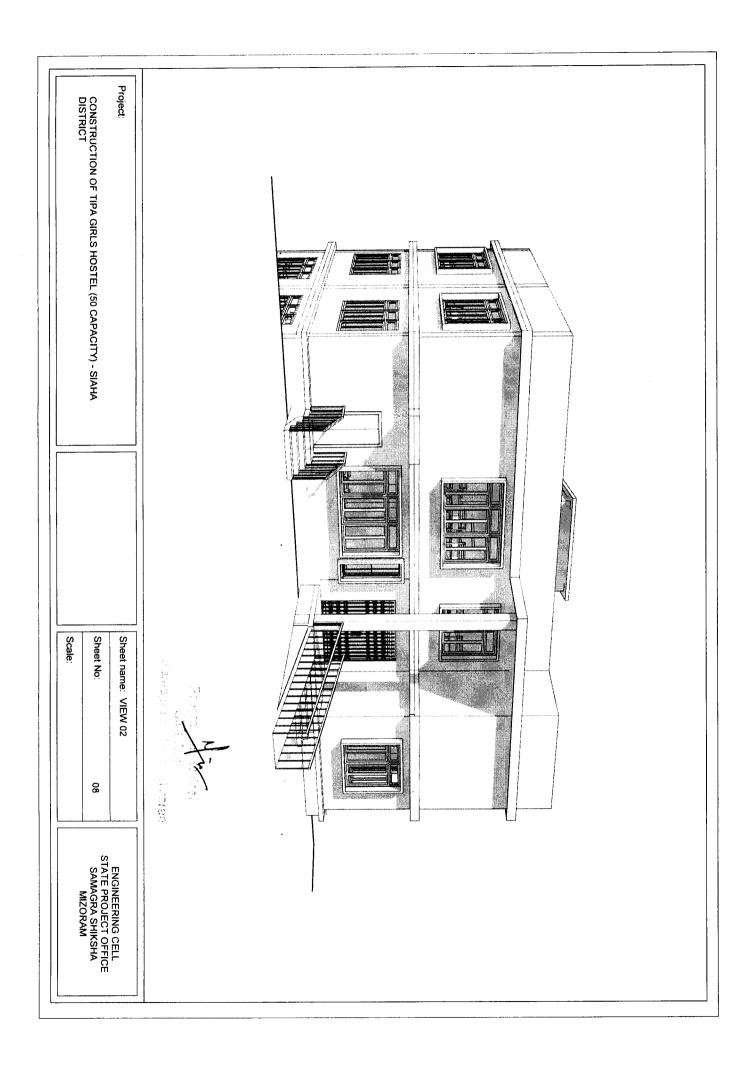


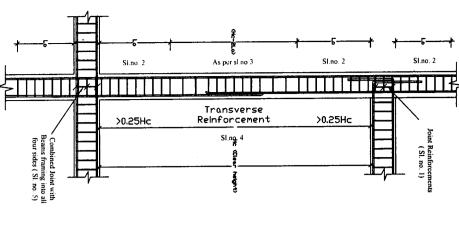













Column and joint detailing

100mm thick P.C.C. 1:3:6 reinforcements > 300 mm Special confining

FOUNDATION TYPICAL

NOTES

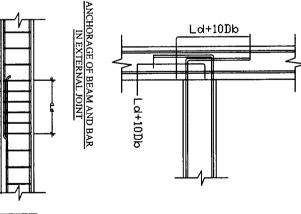
- provided wih special confining steel with a spacing equal to SI.No 2 within the joint Joint which has beam framing into one/two sides shall be
- shall not exceed 1/4 of minimum member dimension but need no 450mm. The spacing of hoops used as special confining steel a). Larger lateral dimension of the member at the section where effect of earthquake forces. The length 'Lo' shall not be less than side of any section where flexural yielding may occur under the length 'Lo' from each joint face, twoards mid span and on either be less than 75mm nor more than 100mm. yielding occurs. b). 1/6 of the clear span of the member. c). Special Confining Reinforcements shall be provided over a
- confining reinforcements is provided for splice. the least lateral dimension of the column, ecept where special The spacing of hoops within 'Hc-2Lo' shall not exceed half
- reinforcements. Lap length shall be 69 thimes the diameter of longitudinal
- required at the end of the column. The spacing of the hoop within provided with a spacing double the special confining steel the hoint shall not exceed 150mm. A Joint which has beams framing into all four faces shall be
- 6. Beam with higher reinforcement should be adopted at the point where two different types of beam meet






Extension of Hoop in column

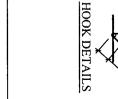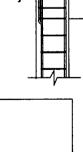BB 075 m)





Db = Bar diameter Ld = Devlopment length in tension

LAP SPLICE IN BEAM

DESIGNED BY:

(Er. DENNIS LALHLIMPUIA) Samagra Shiksha, Mizoram State Project Engineer Civil Works

CONSTRUCTION OF GOVT TIPA-V-III M/S (GIRLS HOSTEL)


FOR STRUCTURAL DETAILS GENERAL SPECIFICATIONS


NTS	SCALE :
-	DRAWING NO:

ALL DIMENSIONS ARE IN ₹

Samagra Schooling, Miles

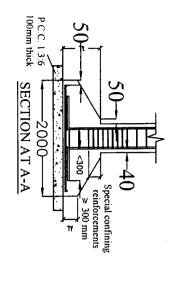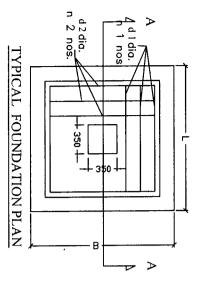FOUNDATION DETAILS





Fl	. Semb	of Footing	
2000 X 2000	LxB	Dimensions:	
150		Tf	
300		Tt	
12 mm	d 1 dia.	L Din	
20	n 1 nos.	L Direction:	
12 mm	Dia. d 2	B Dire	
20	n 2 nos.	B Direction:	

Type of

NOTES:

- 1. P.C.C. 1:3:6 100mm thick shall be provided for levelling course below foundation.
- 2. Special confining reinforcement shall be extended at least 300mm into the footing or mat when column terminates into the footing of mat.
- 3. Clear Cover = 50 mm.
- 4. Concrete Grade = M20, Steel = Fe415(Tor Steel)

CONSTRUCTION OF GOVT TIPA-V-III M/S

SHEET NO: 3

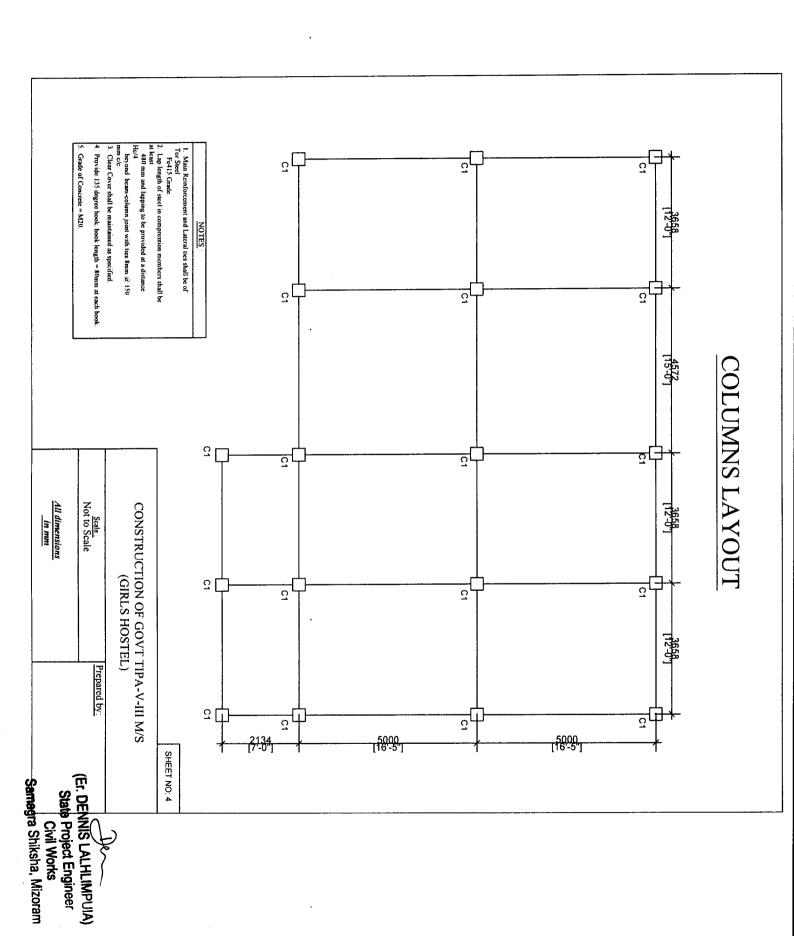
(GIRLS HOSTEL) Prepared by:

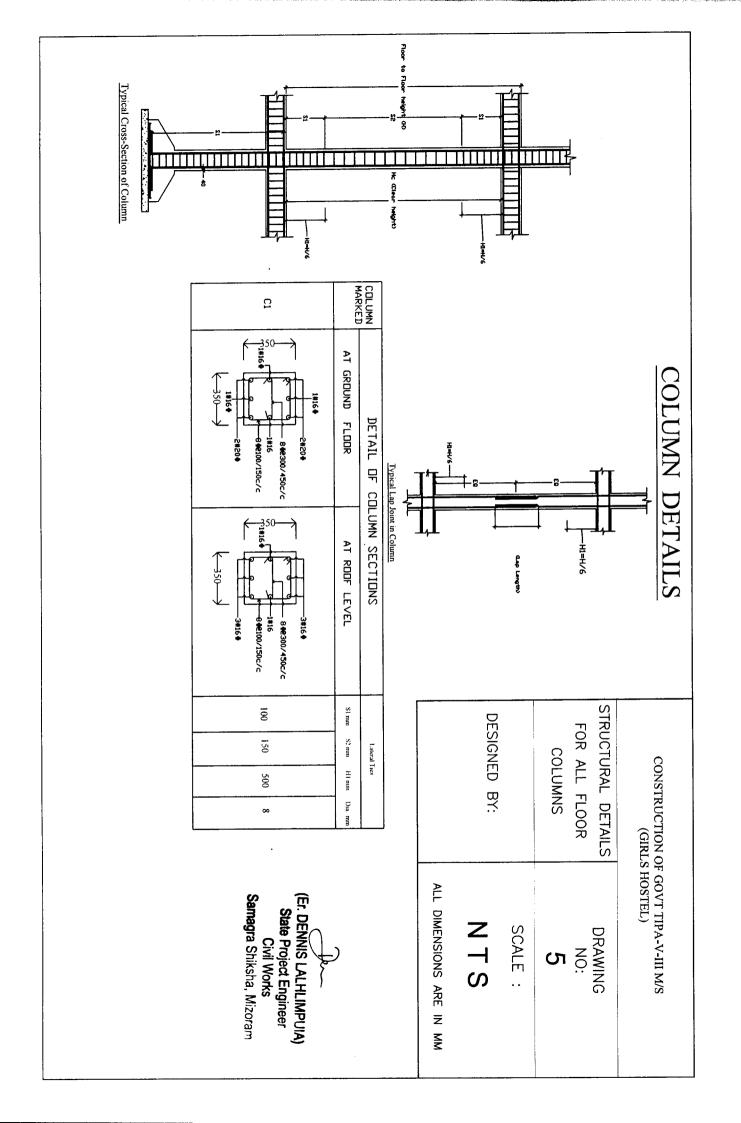
(Er. DENNIS LALHE State Project Engil.

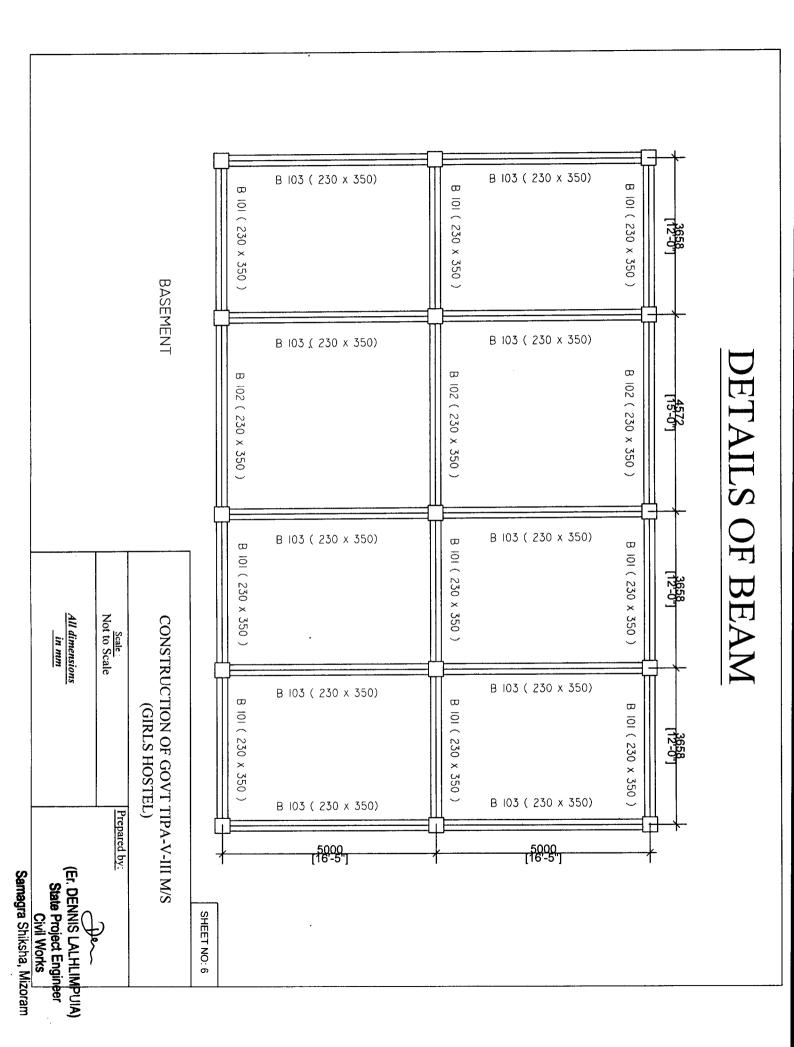
All dimensions in mm

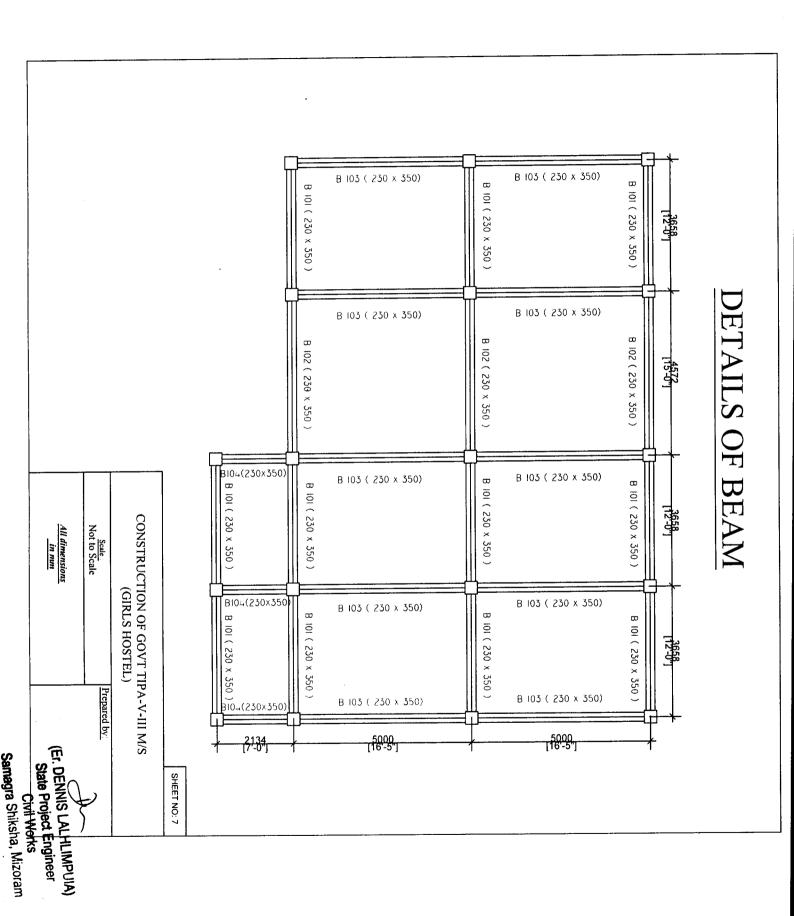
Scale. Not to Scale

Civil Works










DETAILS OF BEAM

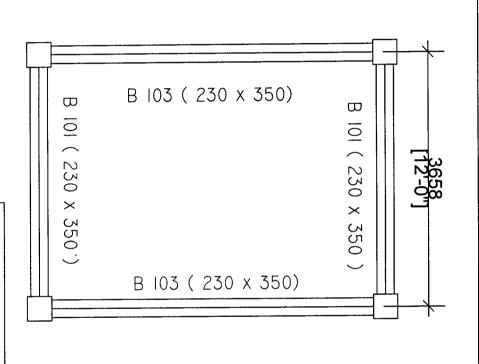

TERRACE LEVEL **MUMTY BEAM**

TIPA-V-III M/S (GIRLS HOSTEL) CONSTRUCTION OF GOVT

SHEET NO: 8

Scale Not to Scale

All dimensions in mm

TYPICAL LONG SECTION OF BEAM





4

в 4

CONTINOUS END

8 4_

DISCONLINOUS END

Where,

SI = Spacing of stirrups for a length of 2d

S2 = Spacing of stirrups in the mid-span

Ld = development length of bar in tension

L = Length of beam (C/C of column)

Typical long section of beam

Clear Cover for Beam = 25mm.

SPECIFICATIONS

Grade of Steel = Fe 415

Grade of Concrete = M 20

4. The first hoop shall be at a distance not exceeding 50mm from the joint face.

5. Minimum Curing Period = 28 days

Beam with higher reinforcement should be adopted at the point where two different types of beam meet.

Fol B	£01 B	B 102	Type of Beam	Fort 8	Type of Beam
230 x 350	230 x 350	230 × 350	Dimensions (mm)	230 × 350	Dimensions (num)
3#16+	3#16+ 2#16+	3#10+	Section at B-B'	3#10+	Section at B-B'
2#16+	2#10.h	2#164	Section at C-C'	2#16+	Section at C-C'
2134	5000	4572	(MA) L	365%	(MW) L
640	lšíni	137/11	(1) (1)	1100	(MM)
320	750	1169	(mm) 2)	550	(MM) 2 1
530	1250	3140	(F)	NG.	(WW)
430	1000	92(1	3) + -	730	(ML)
From du Tor steel. 2 legged. e lou mm see	Soom das Evryteel, 2 legged, 3 100 mm eve	Smm da Tor steel Diegged Siegged	\$ 1	Some du Tor steel. 2 legged g 100 mm ove	S 1
Sman de Tor sice 2 legges è 1% mm	Smoon da Tor stee 2 legges g (50 mm	Smm du Tor steel 2 legged	S	Smm du Ter stee 2 legger g 150 mm	2 5


(Er. DENNIS LALHLIMPUIA)
State Project Engineer
Civil Works Samagra Shiksha, Mizoram


Certified that the requirements of Regulation 30 of

CONSTRUCTION OF GOVT TIPA-V-III M/S (GIRLS HOSTEL)


SHEET NO: 9

Not to Scale	2012, have been complie this struct	the Atzawl Municipal Council Building regulati
All dimensions in mun	2012, have been complied with in the preparation of this structural drawing.	the Aizawl Municipal Council Building regulations,

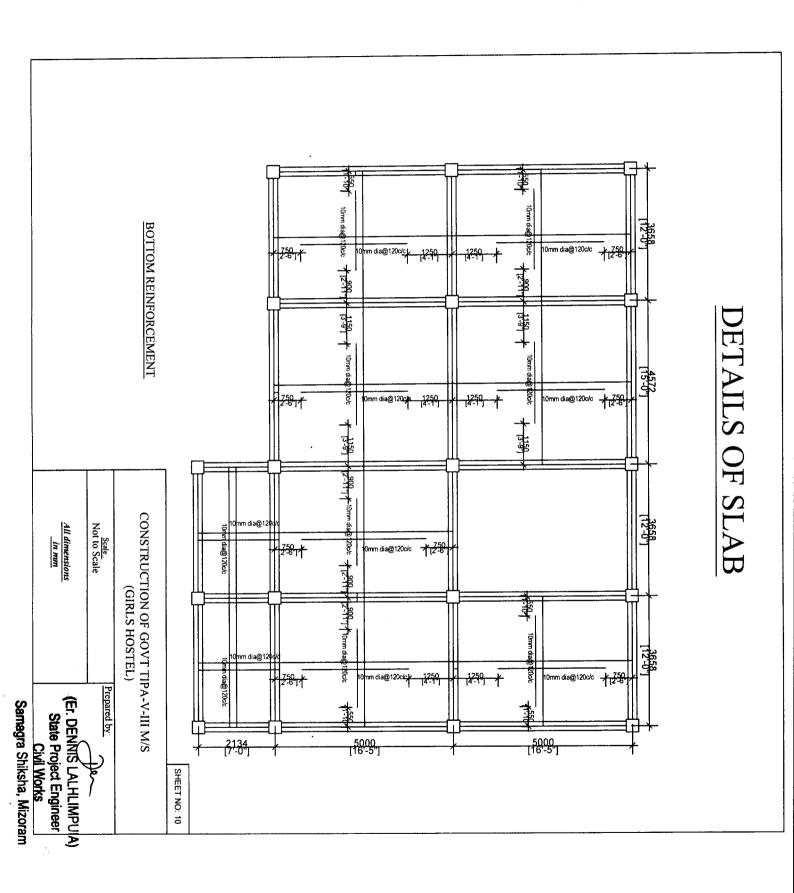

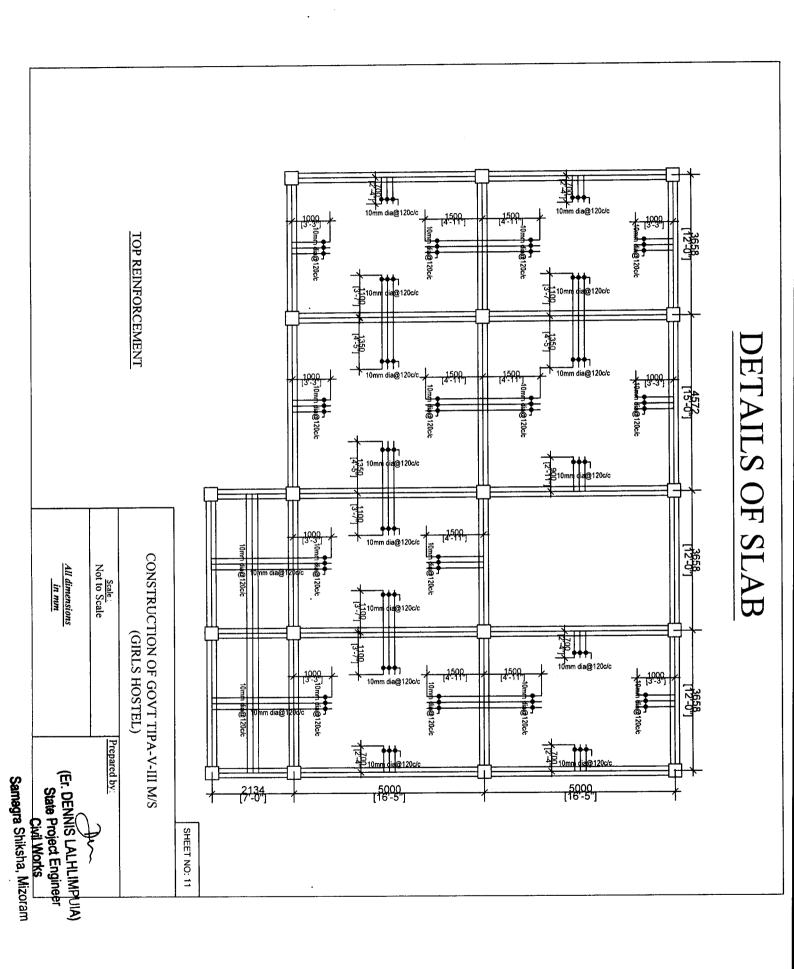

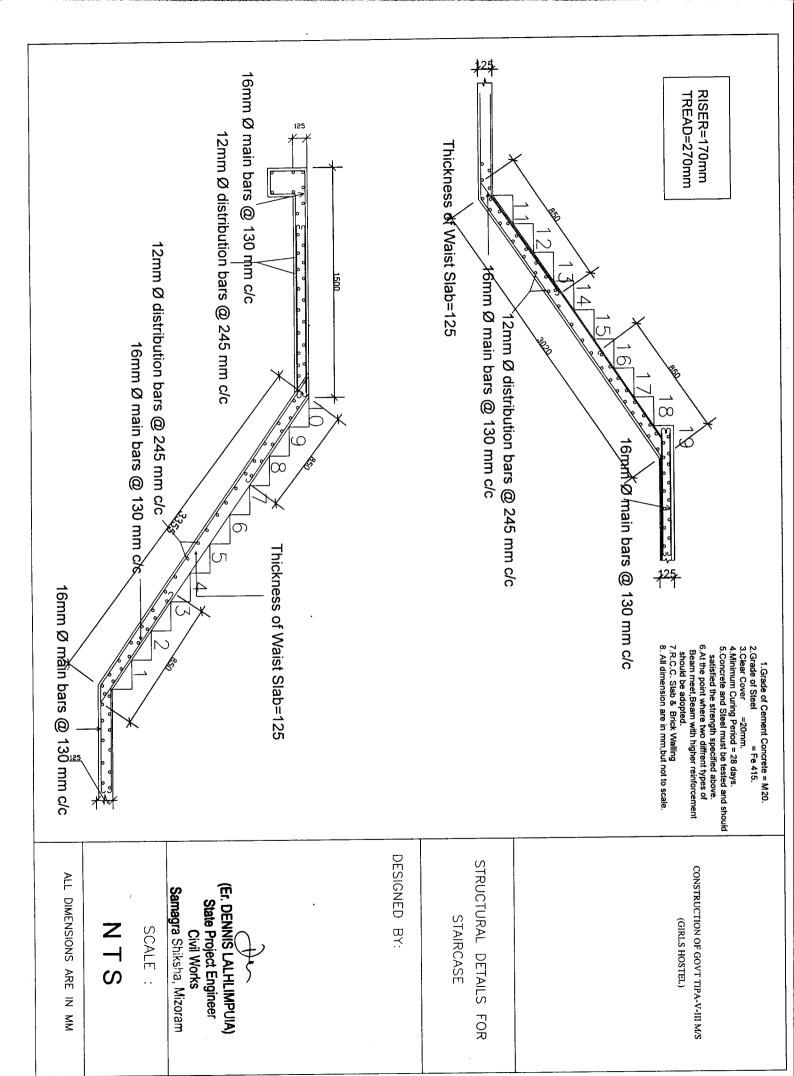DISCONTINUOUS END TYPCAL LONG SECTION OF SLAB AT MID STRIP X-X PLAN OF BOTTOM MAIN REINFORCEMENT PLAN OF TOP MAIN REINFORCEMENT CONTINUOUS END TYPICAL SLAB DRAWING **BEAM** 0.25L24 -0.25L2 +0.15L2 **BEAM** All dimensions in mm Scale Not to Scale CONSTRUCTION OF GOVT TIPA-V-III M/S (GIRLS HOSTEL) (Er. DENNIS LALHLIMPUIA) State Project Engineer Civil Works Shikeha Mizoram SHEET NO: 12 CANTILEVER END



BILL OF QUANTITIES FOR CONSTRUCTION OF GOVT. TIPA V-III M/S (GIRLS HOSTEL)

	5/5.01		4/4.03		3/2.17		2/2.08		1/2.06	Sl.no	
(a) l: 1.5:3 (1 cement : 1.5 coarse sand : 3 graded stone aggregate 20mm nominal size)	excluding and laying in position reinforced cement concrete excluding cost of centering and shuttering, finishing and reinforcement in - All work upto plinth level:	b) aggregate 40mm nominal size)	Providing and laying in position cement concrete of specified grade excluding cost of centering and shuttering - All work upto plinth level:	2/3 of qty taken from 2/2.08	Filling available excavated earth (excluding rock) in trenches, plinth, sides of foundations etc. in layers not exceeding 20cm in depth, consolidating each deposited layer by ramming and watering, lead up to 50 m and lift upto 1.5 m.	(a) Oridinary Soil	Earthwork in excavation in foundation trenches etc. not exceeding 2 meters depth including dressing of bottom and sides of trenches and subsequent filling and compaction in 15cm layers as in column foundations, fence posts, etc. and disposal of all surplus soil as directed within a lead of 30 metres.	(a) Oridinary and Hard Soil	Earthwork in excavation over areas (exceeding 30cm in depth, 1.5m in width as well as 10sqm on plan) including disposal of excavated earth, lead upto 50m and lift upto 1.5m, disposed earth to be levelled and neatly dressed.	Description of Items	
cum		cum	·	cum		cum		cum		Unit	
29.169		23.604		86.400		129.600		433.000		Qty	
										in figure	
								the state of the s		in words	Rate
										Amount	

																	т		т	
10/6.09														9/5.10	. ;	8/5.18		7/5.03		6/5.02
	┢	Ð	-	e)				d)	H	_		c)	(a)		<u>b</u>		a)	Rei floo she stai floo fini	a)	Rei atta retu laci cos
7.5 cm thick brick masonry with first class brick in superstructure above plinth level upto floor two level including curing, etc. complete.	excluding landings.	Staircases (except spiral staircase)	support, balconies and chajjaj,etc.	Suspended floors, roofs, landings, shelves and their	230x350 mm	Beams.	cantilevers, etc.	Lintels, beams, plinth beams, girders, bressumers and	350x350 mm	Column	posts and struts.	Columns, pillars, piers, abutments,	Foundations, footings, bases of columns etc. for mass concrete.	Centering and shuttering including strutting, propping, etc. and removal of form works in -	Thermo-Mechanically Treated Bars	Steel reinforcement for RCC work including straightening, cutting, bending, placing in position and binding all complete	I:1.5:3 (1 cement : 1.5 coarse sand : 3 graded stone aggregate 20mm nominal size)	Reinforced cement concrete work in beams, suspended floors, roofs having slope up to 15° landings, balconies, shelves, chajjas, lintels, bands, plain window sills, staircases and spiral stair cases above plinth level up to floor five level, excluding the cost of centering, shuttering, finishing and reinforcement complete.	1:1.5:3 (I cement : 1.5 coarse sand : 3 graded stone aggregate 20mm nominal size)	Reinforced cement concrete work in walls including attached pillasters, columns, pillers, posts, piers, abutments, return walls, retaining walls, struts, buttresses, string or lacing courses, fillets etc. upto floor five level excluding cost of centering shuttering etc complete.
	sqm		sqm		sqm				sqm				sqm		kg		cum		сит	
	47.80		970.41		364.56				210.000				42		31753.630		148.29		21.99	



	16/10.10	15/20.11	14,11.00	14/11 02		13/11.01		12/9.10	11/9.06	
a) GI tube 40mm @ 3.72 Kg/m	Providing and fixing hand rail of approved size by welding etc. to steel ladder railing, balcony railing, staircase railing and similar works, including applying priming coat of approved steel primer. (round, square or rectangular hollow tubes etc.)	1 15mm cement plaster 1:3 (1 cement: 3 fine sand).	1 l_	11	a) Natural colour	Providing and fixing anodised aluminium work for doors, windows, ventilators and partitions with extruded built up standard sections/ other sections of approved make conforming to IS: 733 and IS: 1285 fixing with dash fasteners of required dia and size. including necessary filling up of gaps at junctions, at top, bottom and sides with required PVC/ neoprene gaskets etc. Aluminium sections shall be smooth, rust free, straight, mitred and jointed mechanically wherever required including cleat angle, aluminium snap beading for glazing /panelling, CP brass /stainless steel screws all complete including fixing of glasses but excluding cost of glasses.	a) 40 mm thick.	Providing and fixing 1st class teak wood <i>panelled</i> shutters for doors etc. including M.S. butt hinges with necessary screws, etc. complete.	Providing Ist class local wood dressed in frames of chaukat for doors, windows, clerestory windows fixed in position.	a) in cement moratar 1:3 (1 cement: 3 coarse sand)
kg		sqm	sqm	sqm			sqm		cum	sqm
1009.24		3150.32	95.44	95.44			65.38		1.824	748.276



				25/18.01		24/14.10		23/14.07		22/14.11	21/20.50		20/20.75		19/20.72	18/20.51		17/12.11
connections for inlet, outlet and overflow pipes but without the cost for base support.	suitable locking arrangement and making nescessary	manufacture with cover and mosquito proof coupling and	Polyethylene storage tank of approved brand and	Щ	(a) 150mm	Providing and fixing M.S. handles with necessary screws, etc. complete	(a) 300 mm	Pro	a) Union type	Providing and fixing bright finished M.S two lever mortise door lock with necessary screws, etc. complete.	Applying one coat of water thinnable cement primer of approved brand and manufacture on wall surface:	a) Regular exterior emulsion like supercote, walmasta etc.	Finishing walls with exterior emulsion of required shade on new work (three or more coats) to give an even shade.	a) General quality	Painting with synthetic enamel paint of approved brand and manufacture in all shades on new work (two or more coats).	Applying priming coat with ready mixed pink or Grey primer of approved brand and manufacture on wood work (hard and soft wood) & Plywood.	b) Matt/Antiscratch	Providing and ceramic glazed floor tiles of size 300x300mm or more (thickness to be specified by the manufacturer) of 1st quality conforming to IS: 15622 of approved make in all colours, shades, except white, ivory, grey, fume red brown, laid on 20mm thick cement mortar 1: 4 (1 cement: 4 course sand) including pointing the joints with white cement and matching pigments etc. complete, as per designed colour.
					Nos		Nos		Nos		sqm	sqm		sqm		sqm	sqm	
					48.00		48.00		12.00		3150.32	3150.32		102.096		102.10	80.88	



		33/18.25		32/17.04			31/17.02		30/17.42		29/17.37		28/17.35		27/17.34		26/17.33	
(b) 20mm dia nominal bore	1	Providing and fixing PVC pipes complete with fittings and	i) White	Providing and fixing vitreous china pedestal type water closet (European type W.C. pan) with seat and lid. 10 litre low level white P.V.C. flushing cistern, including flush pipe, with manually controlled device (handle lever), conforming to IS: 7231, with all fittings and fixtures complete, including cutting and making good the walls and floors wherever required:	(i) White	(a) Orissa pattern pan with integral type foot rests	Providing and fixing water closet squatting pan (Indian type W.C. pan) with 100 mm uPVC P or S trap, with all fittings and fixtures complete, including cutting and making good the walls and floors wherever required: (Without Cistern)	a) 110 mm dia.	Providing and fixing ventilation cowl including jointing with rubber lubricant/cement solvent complete.	a) 110x110x110 mm	= 9	a) 110 mm dia.	3 60 3 1	a) 110 mm dia.	Providing and fixing SWRPVC plain bend of required degree (87.50°) including jointing with rubber lubricant/cement solvent complete.	a) 110mm dia.	Providing and fixing on wall face SWRPVC soil, waste and vent pipes including jointing with rubber lubricant/cement solvent complete.	a) Sintex or quivalent
rm			Nos		Nos			Nos		Nos		Nos		Nos		m		lit
50.000			1.00		9.00			7.00	į	17.00		15.00		22.00		100.00	·	8000.00



	42/17.30		41/17.29		40/17.24		39/18.51			38/17.16				37/10.07	27/10 00	36/18.08		35/18.07		34/18.02
b) Plastic toilet paper holder of standard size.	Providing and fixing toilet paper holder.	a) 750x20mm size.	Providing anf fixing anodised alluminium towel rail with two anodised alluminium brackets to wooden cleats with C.P brass screws.	Total	Providing and fixing mirror of superior glass (of approved quality) and of required shape and size with plastic moulded frame of approved make and shade with 6 mm thick hard board backing:	(b) 750 watts	Providing and placing in position electric water pump of approved manufacture including connections to G.l pipes etc. complete with accessories.	i) white	b) Vitreous China Wash basin Compact 450 x 300 mm with single 15 mm C.P. brass pillar taps	make with R.S. or C.I. brackets, 15mm C.P. brass pillar taps, C.P. brass chain with rubber plugs, 32mm C.P. brass waste of standard pattern, 32mm C.P. brass traps and union complete including painting of fittings and brackets, cutting and making good the walls wherever required.	Providing and fixing White vitreous china wash basin Standard of Parryware/ Hindware/ Cera and equivalent	b) 20 mm nominal bore	complete (New work) .	cutting and threading the pipe and making long screws etc.	b) 20mm nominal bore	Providing and fixing brass stop cock of approved quality.	b) 20mm nominal bore	Providing and fixing brass bib cock of approved quality.	a) 20mm dia nominal bore	Providing and fixing G.I. pipes complete with G.I. fitting and clamps, including cutting and making good the walls etc. (internal works- exposed on wall).
Nos		Nos		Nos		each		Nos				Nos			Nos		Nos		rm	
1.00		1.00		9.00		1.00		9.000				15.000			27.000		15.000		50.00	



3/5.10		2/5.03		1/2.08		47/10.04		46/12.01		45/10.16		44/7.01		43/17.31
Cen and	(a) aggregate 20mm nominal size)	Reinforced cement concrete work in beams, suspended floor reinforcement complete.	(a) Oridinary Soil	Earthwork in excavation in foundation trenches etc. not exceeding 2 meters depth including dressing of bottom and sides of trenches and subsequent filling and compaction in 15cm layers as in column foundations, fence posts, etc. and disposal of all surplus soil as directed within a lead of 30 metres.	SEPTIC TANK	Providing and fixing in position collapsible steel shutters with vertical channels 20x10x2mm and braced with flat iron diagonals 20x5mm size with top and bottom rails of T-iron 40x40x6mm with 40mm dia. steel pulleys complete with bolts, nuts, locking arrangement, stoppers, handles, including applying a priming coat of approved steel primer.	40 mm thick with 20 mm nominal size stone aggregate	Cen grac coat excl	b) In a grating, frames, guard bar, ladders, railings, brackets, gates & similar works.	Stee incl prir etc.	c) in cement mortar 1:6 (1cement:6 fine sand)	Reg fou incl	a) Glass container with C.P. lid and brackets.	Providing and fixing liquid soap container with C.P. brass lid and brackets fixed to wooden cleats with C.P. brass screws.
	m³		m³			sqm	sqm		kg		cum		Nos	
	1.185		12.400			80.01	553.00		1031.07		67.50		1.00	
		:												



						d		7/6.08 H			7 00 2/3			c	5/5.18 c	S	4/20.08	(6
						b) in cement mortar 1:4 (1 cement : 4 fine sand)	including curing, etc. complete	Honey-comb of half brick masonry with first class brick	(b) in cement mortar 1:4 (1 cement : 4 fine sand)	including curing, etc. complete .	7.5 cm thick brick masonry with first class brickl	@ 0.62/ Rm	(b) Thermo-Mechanically Treated Bars	complete	cutting, bending, placing in position and binding all	Steel reinforcement for RCC work including straightening,	12mm cement plaster 1:4 (1 cement: 4 fine sand).	(e) Suspended floors, roofs, landings,
						m²			m²			rm					m²	m²
						7.36			6.28			66.87					14.795	4.671
GRAND TOTAL	Add GST(6%)	Add Labour Cess(1%)	Total of Civil Work inclusive of Cost Indices	Add C.I for Siaha Dist.(42.75%)	TOTAL													

BILL OF QUANTITIES

NAME OF WORK: INTERNAL ELECTRIFICATION OF NSCBAV (GIRLS HOSTEL), TIPA V-III MS; SIAHA DISTRICT

& capping (Gr-II) 20x12mm fi /floor as per convenience inc required numbers of ways fro 5/6A point etc. as required:-	copper conductive retardant low copper flexible	C:02:01 (D) Li LIGHT PLUG/	FAN POINT	C:02:01 (D) Lo	C:02:01 (C) M	C:02:01 (B) SI	LIGHT POINT	light point etc as required:-	C:02:01 having required	wall/ceiling/flo	& capping (Gr-	copper flexible	retardant low s	copper conduc	Wiring in loop	(MODULAR TYPE)	LIGHT POINT,C	C:02:00 SURFACE PVC	301	SOR
as i equited	copper conductor/wires as per IS:694 (1990) and Flame retardant low smoke & Halogen (FR-LSH) 1100 voltage graded copper flexible wire stranded copper running inside PVC casing & capping (Gr-II) 20x12mm fixed, surface on the wall/ceiling /floor as per convenience including junction box having required numbers of ways from DB to the light plug/socket 5/64 point etc. as required.	C:02:01 (D) Long Point (Modular) LIGHT PLUG/SOCKET POINT 5/6 AMPERES (MODULAR TYPE) Wiring in looping system with DVC wire sheathed standard		C:02:01 (D) Long Point (Modular)	C:02:01 (C) Medium Point (Modular)	C:02:01 (B) Short Point (Modular)		as required:-	having required numbers of ways from control switch to the	wall/ceiling/floor as per convenience including junction box	& capping (Gr-II) 20mm dia fixed, surface on the	copper flexible wire stranded copper running inside PVC casing	retardant low smoke & Halogen (FR-LSH)1100 voltage graded	copper conductor/wires as per IS:694 (1990) and Flame	Wiring in looping system with PVC wire sheathed standard	<u>PE)</u>	LIGHT POINT, CEILING FAN POINT, EXHAUST FAN POINT ETC	SURFACE PVC CASING &CAPPING COPPER WIRING (GRADE-II)		DESCRIPTION OF MATERIAL
		Each		Each	Each	Each													01411	INI
		13		18	24	33													4	OTIENATIO
																			in words	
																			in figure	RATE
																				TUIIOMA



	1:02:00																			-	C:02:06										-	C:02:03)			
_		r -	<u> </u>	I →		<u></u>	S	bro	IS	е.		е		Ф		0	_		S	00		=	<u></u>	_	 	<u> </u>		е	3	a	0			<	<u> </u>	
Two modules Switch Board (Modular)	1:02:03 1 S two ways	1:02:01 15	One Module Switch Board (Modular)	fan regulators etc. with necessary painting if necessary	boxes, modular plate and necessary switches, plug/socket, and	following sizes/modules on surface/recess including PVC/Steel	Supplying and fixing of Modular switch board grade-II of the	grade-II	SUPPLYING AND FIXING OF SWITCH BOARDS (MODULAR TYPE)	earth wire	C:01:06(C) 2X 6 Sqmm copper conductor/cable + 1 x 6 Sqmm	earth wire	C:02:06(B) 2X4 Sqmm copper conductor/cable + 1x4 Sqmm	earth wire	C:02:06(A) 2X2.5 Sqmm copper conductor/cable + 1x2.5 Sqmm	boards as required:-	Main/DB/Sub-Main/DB to SDB/SDB/Switch boards/SDB to switch	junction box having required numbers of ways from Main to Sub-	surface on the wall/ceiling/floor as per convenience including	& capping (Grade-II) of all available sizes diameter fixed,	copper flexible wire stranded copper running inside PVC Casing	retardant low smoke & Halogen (FR-LSH) 1100 voltage graded	copper conductor/wires as per IS:694 (1990) and Flame	Wiring in looping system with PVC wire sheathed standard	(SINGLE PHASE TWO WIRES)	MAIN TO SUB-MAIN IN COPPER WIRE GRADE-II SURFACE	C:02:03(D)Power plug Point 15/16 A Long Point (Modular)	etc. as required :-	numbers of ways from DB to the power plug/socket 15/16A point		capping (Gr-II) 30x12mm fixed, surface on the wall/ceiling /floor	flexible wire stranded copper running inside PVC casing &	copper conductor/wires as per is 594 (1990) and Flame retardant low smoke & Halogen (FR-I SH) 1100 voltage graded copper	Wiring in looping system with PVC wire sheathed standard	TYPE)	POWER PLUG/SOCKET POINT 15/16 AMPERES (MODULAR
	No	No								rm		1311	3	=	3												Each									
	6	11								90		135		540													w									
					·-·									·																	· '					

J:01:00				J:00:00		0:03:00		0:00:00				N:01:00			N:00:00							
(1377) LED Batten fitting 1X26W Linea 4' with LED tube (Phillips/equivalent)	(1375) LED Batten fitting 1X12W Linea 2' with LED tube (Phillips/equivalent)	J:01:30 Installation, testing & commissioning of pre-wired flourescent Light fittings of all types, with all accessories and tubes etc, directly on ceiling/wall, including connection with 1.5 Sqmm copper conductor single core cable etc as required.	J:01:03 Supplying, fitting and fixing Batten Holder including connection etc, as required (1661) CFL Curvy 15W(SP) B22,E27 Base Havells/Equivalent	LIGHTING FIXTURES(SURFACE/RECESS) LIGHTING FIXTURES CEILING/WALL MOUNTED:-	O:03:75 6-ways MCB DB SP & N DD metallic Door	with Bakelite fused fitting with fused links,240 volts,50 Hz AC on surface/recess completed with inter-connection, painting etc, as required.	MCB DISTRIBUTION BOARD Supplying, fitting, & fixing of 63 Amps' 6-ways Distribution Board	DISTRIBUTION BOARDS	N:01:27 63 Amps' DP, MCB Isolator	N:01:26 40 Amps' DP, MCB Isolator	N:01:01 5 to 32 Amps ,SP, MCB B- series	complete with connections, testing & commissioning etc in	Supplying and fixing of all types and rating MCBs, RCCBs, ELCBs	MCBs SP/SP&N/DP/TP/TP&N/FP	SP/SPN/DP/DP&N/TP/TP&N/FP	1:02:158 3 S + 1SOC +1R+ 1BKP	Eight modules Switch Board (Modular)	1:02:86 2 S + 1 R + 1SOC	Six modules Switch Board (Modular)	l:02:57 2S with indicator + 1Soc	Four modules Switch Board (Modular)	1:02:13 2 5
<u>N</u>	2 0	Each	Each No		Each				Each	Each	Each					No		No		N 0		N _O
32	11	44	30 30		3				1	2	12					7		6		ω		10
																		7.00				

		D1:00 LIGHTNING CONDUCTOR	R:01:00
		L.,	
	Metre 767.7	cassing & capping	
		cooper conductor for loop earthing in the existing	
		Q:01:55 Supplying and drawing of 1.5 sqmm PVC sheathed	
		dia '))	
	Metre 18		
	- 4	50mbelow ground level for conductor earth electrode	
			Q:01:00
	tach 1	earth electrode as required.)
		Q:01:10 Extra for using salt and coke for G.I or copper plate	
		and salt) complete as required.	
		arrangment and water pipe, etc. (but without charcoal or coke	
•	Each 1	providing masonery enclosure with cover plate having locking	
		600mmx600mmx6mm thick including accessories and	
		Q:01:07 Earthing with Copper Earth plate	
		EARTHING AND LOOP EARTHING	<u> </u>
	3	Rio /Equivalent	
		(1828)Electric Storage Water Heater/Geyser 6 litres 2 KW Havells	
	3	required.	
		good the damage, connection, testing and commissioning etc, as	
	Each	for the above Instantaneous Electric Water Heater, and making	J:02:00
	-	×	
		to 50 litres in the existing wall including fixing the Hook in the	
		J:02:02Installation of Instantaneous Electric Water Heater up	
		J:02:00Installation of all kind of Electrical appliances	
	13	(Usha/Crompton/Equivalent)	
		(1845)Ceilling fan 1200mm Sweeps ISI marked 3 blades	
	6	remote ISI marked (Usha/equivalent)	
		(1861)Bracket wall mounting fan 400mm sweeps Helix with	
	19	single core cable etc, as required	
	Eacn		
	-		
		J:01:36 Installation, testing & commissioning of ceiling fan and	
	<u> </u>	Havells/equivalent	
	N 0	light luminaire for twin high Wattage Retrofit CFL.	-
		(1625) Flood Light 2X65W CFL Retro ZING 2 Polycarbonate flood	


(Er. DENKIS LALHLIMP' IIA)
State Project Engineer
Civil Works

		RS	GRAND TOTAL
			Add 1% Labour Cess
			Add 18% GST
			Total
			Aluminium cable lump sum
			1- Phase Service connection 16sqmm twin core
	٠	רמכוי	pipe line as required in lump sum
	.	E 22	Supplying and fitting of Water Cooler 120 ltrs with water
	10	ואוכנו כ	from earth electrode directly in ground as required.
	10	Motro	R:01:67Providing and laying of copper tape 32mmx6mm thick
			(DOKSUN/Equivalent) in complete
	۰	EGCI	with base plate to mount lightning Arrestor
	•	5	lightning Arrestor 50m 3 meters long made of SS-304 material
			R:01:10Providing and fixing of Stainless steel pole for ESE
			micro second delay (DOKSUN/equivalent)
	7		area of 63m diameter lightning charge capacity 100 KA and 43
	-	EdCII	Duly tested and certified by CPRI Bangalore, Having coverage
			standardized according to norms UNE 21.186 AND NPC 17.102
	J.:.		6.5 (DPDC 6.5) with non electric ESE(Early steamer Emission)
			R:01:08Providing and fixing of ESE type lightning Arrestor PDC

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Programme Officer
Civil works
Samagra Shiksha, Mizoram

(Er. DENNIS LALHLIMPUIA)
State Project Engineer
Civil Works
Samagra Shiksha, Mizoram

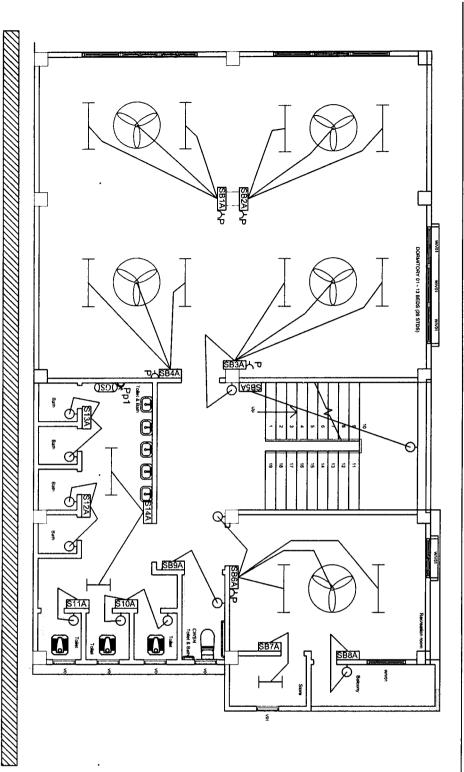Rupees in words



Wall mounting light(15 W CFL)

1200mm sweep Ceiling fan

Control Switch board(Modular)

Samp S/S comb Plug 16amp S/S comb Plug Guyser 6 litres

Flood light(2X65 W CFL)

LED Batten fitting 1 x 12W 2' with LED tube

LED Batten fitting 1 x 20W 4' with LED tube

LEGENDS


SHEET NO: I

BASEMENT

Water Cooler 120 ltrs

Circuit Distribution board Main Distribution Board

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Samagra Shiksha, Mizoram

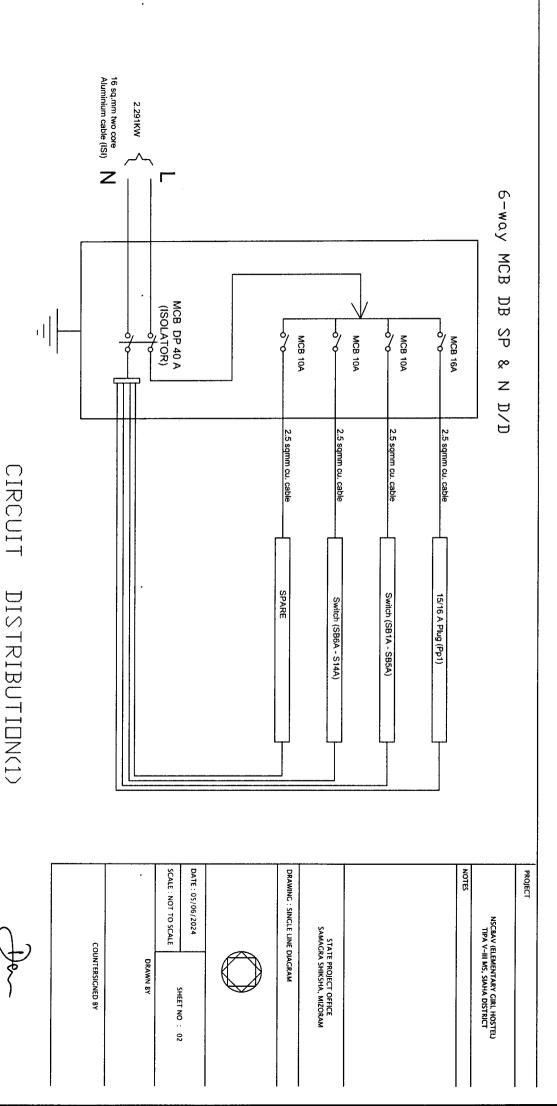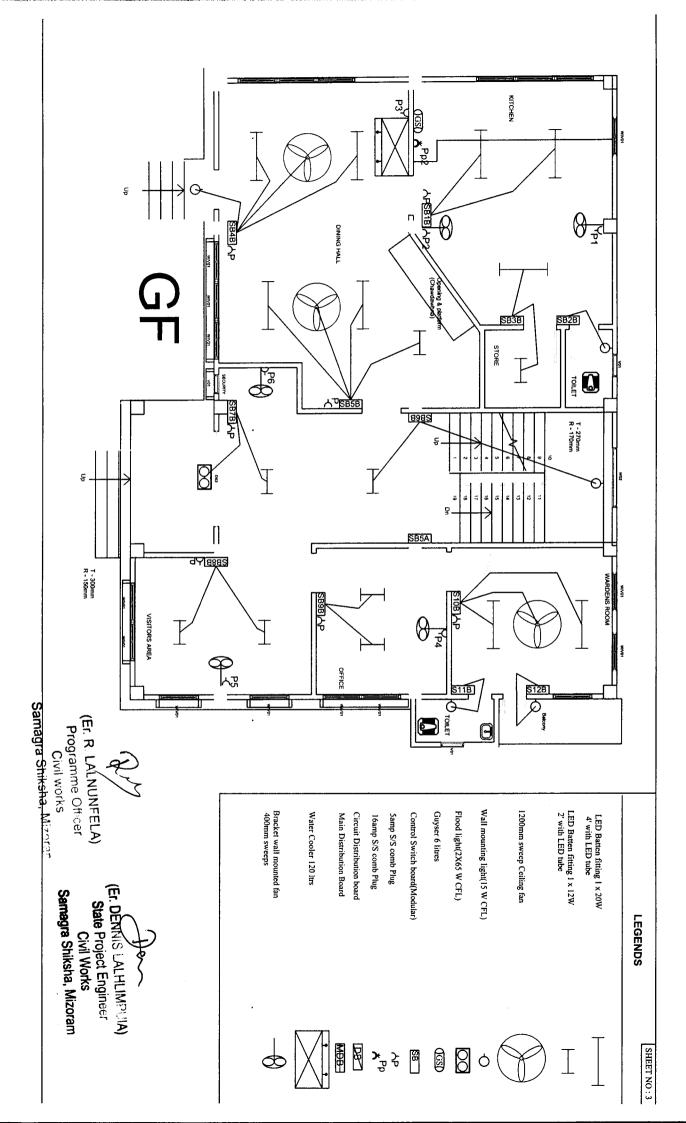


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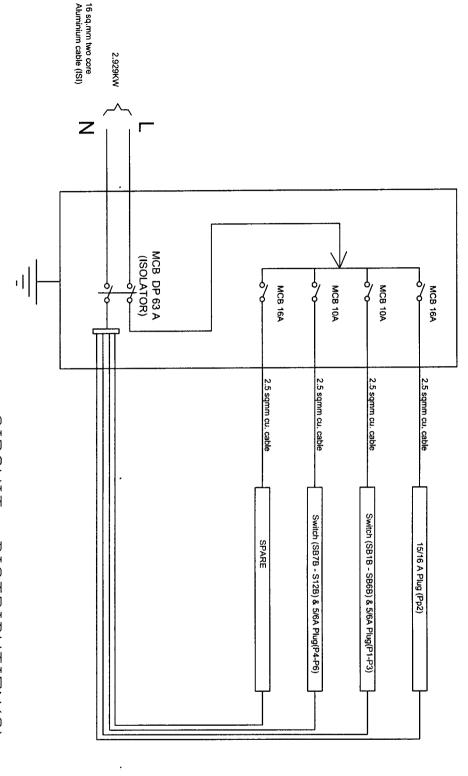


6-way MCB DB SP ∞ N D/D

PROJECT

NOTES

NSCBAV (ELEMENTARY GIRL HOSTEL) TIPA V-III MS, SIAHA DISTRICT



DATE: 05/06/2024

DRAWING: SINGLE LINE DIAGRAM

STATE PROJECT OFFICE SAMAGRA SHIKSHA, MIZORAM

SCALE: NOT TO SCALE

SHEET NO : 04

DRAWN 8Y

COUNTERSIGNED BY


CIRCUIT DISTRIBUTION(2)

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SHEET NO: 5

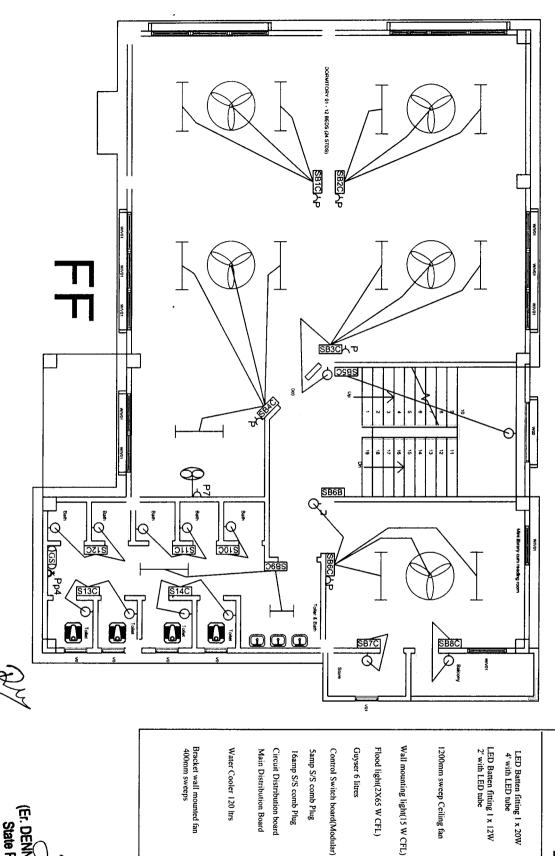LEGENDS

