




### CHANMARI GIRLS HOSTEL (50 Capacity) AT LAWNGTLAI DISTRICT CONSTRUCTION OF

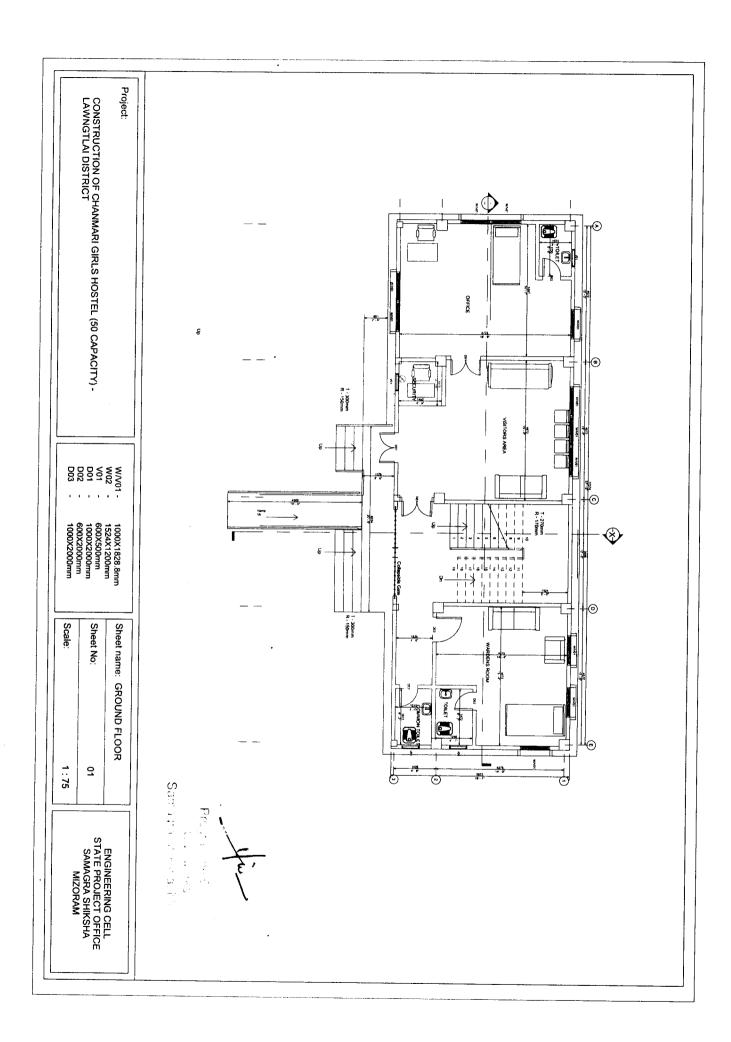


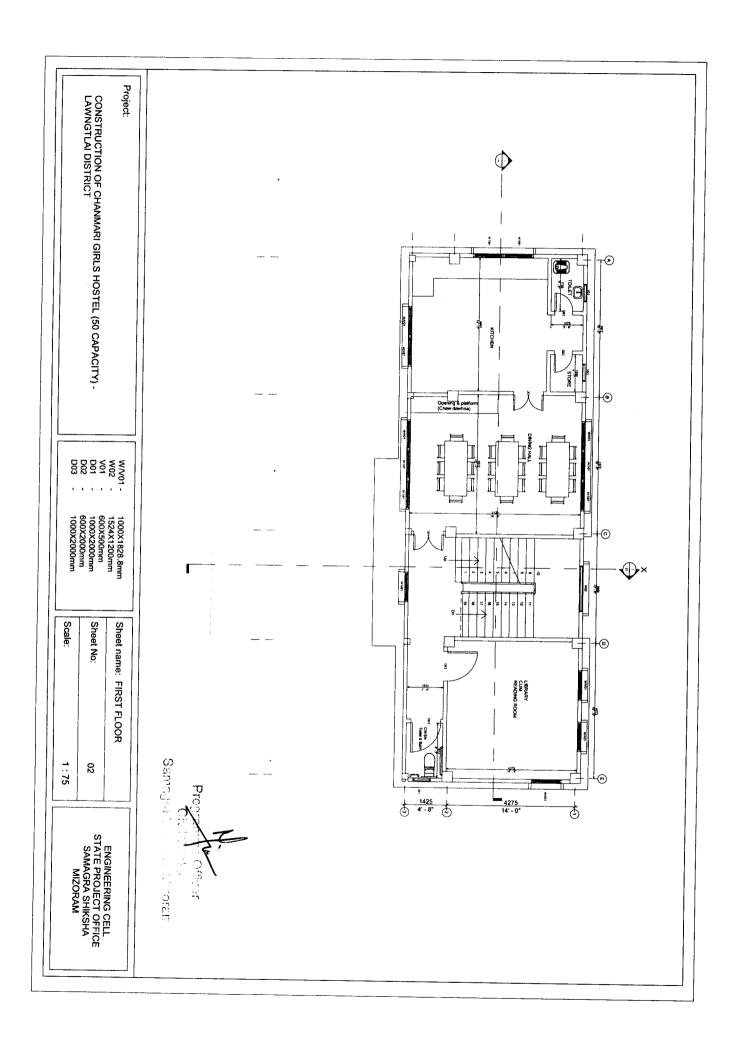


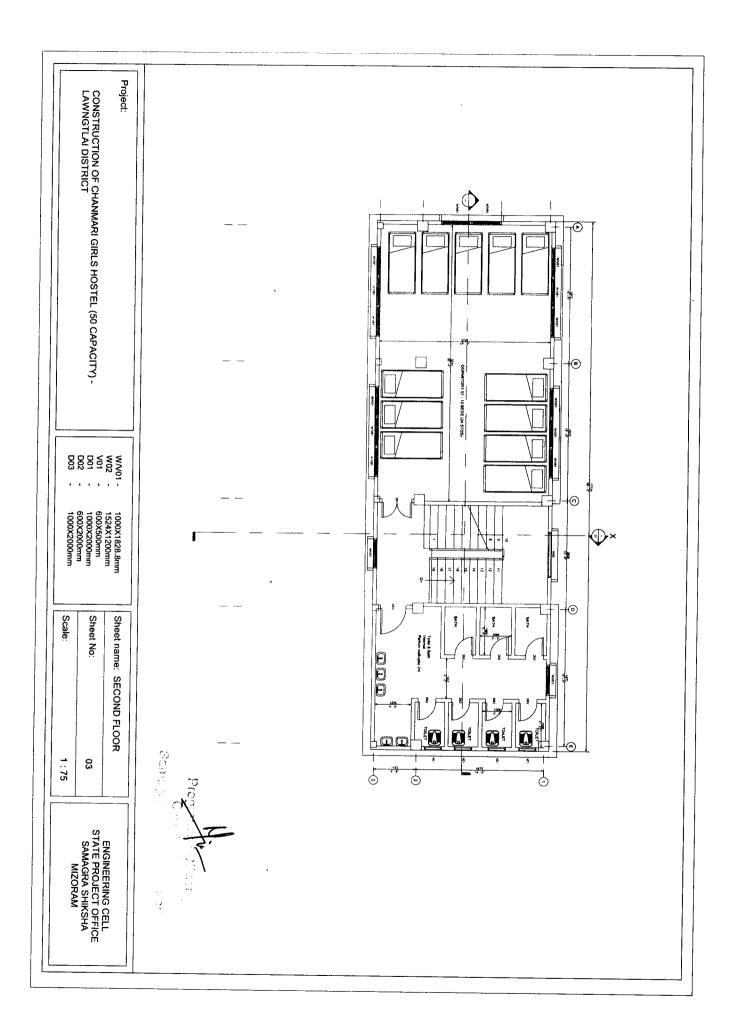


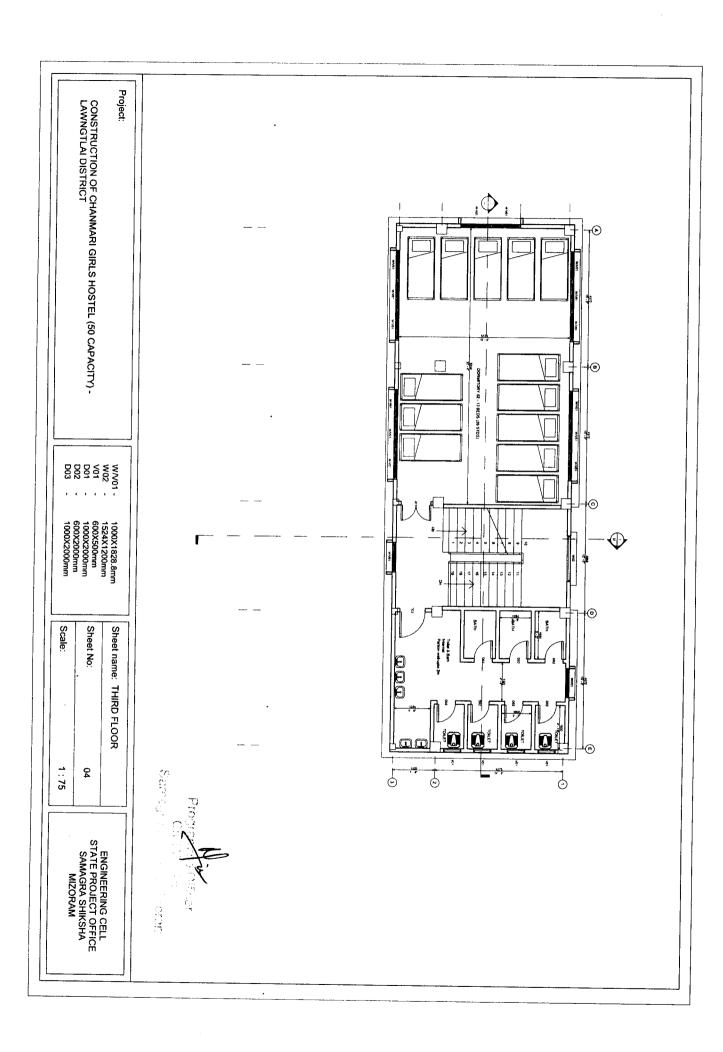


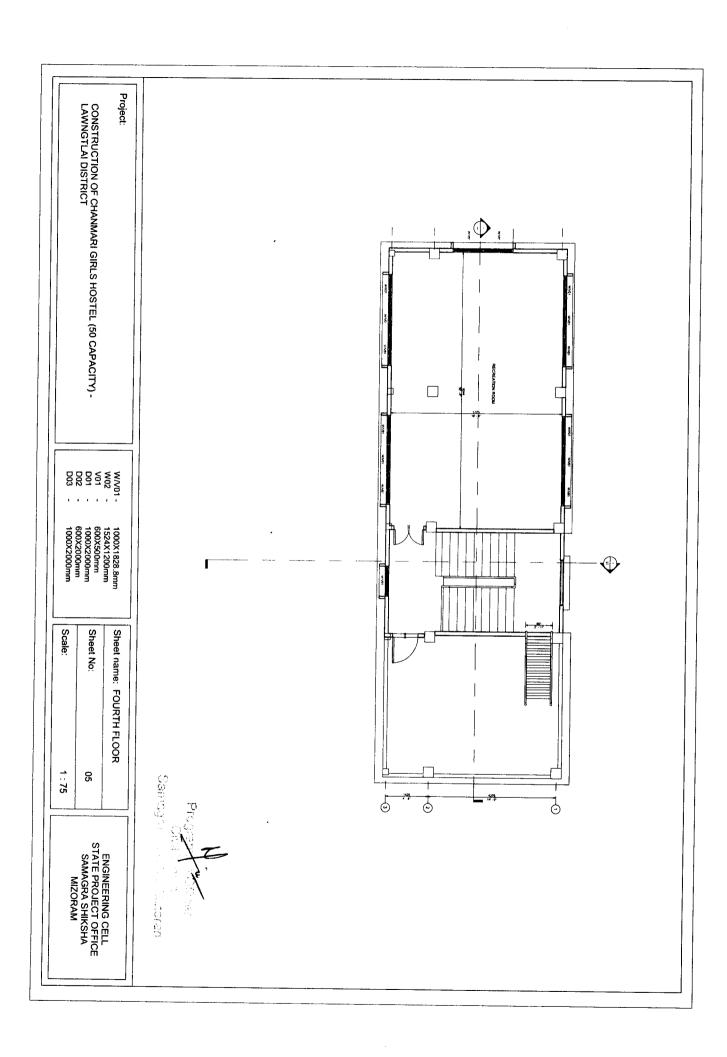

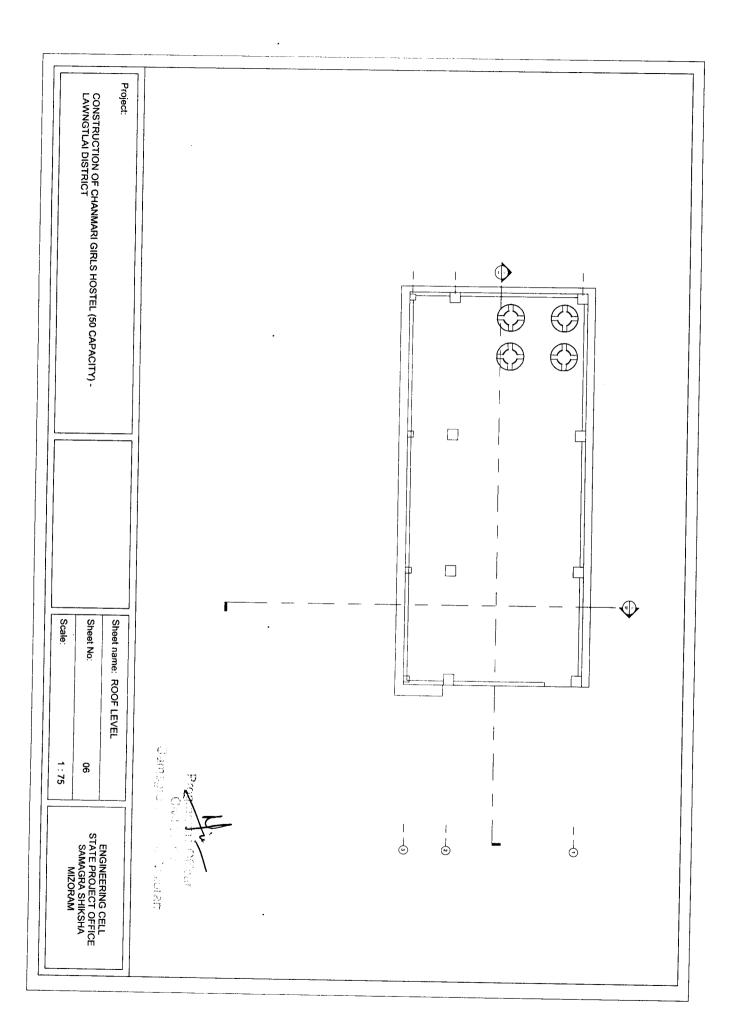


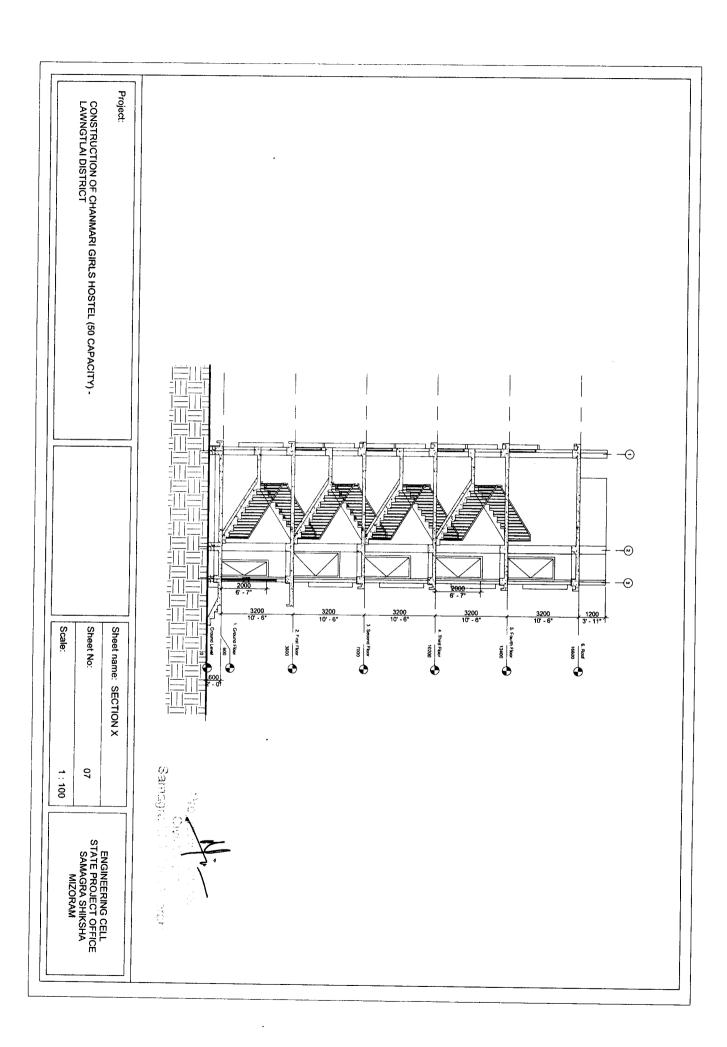


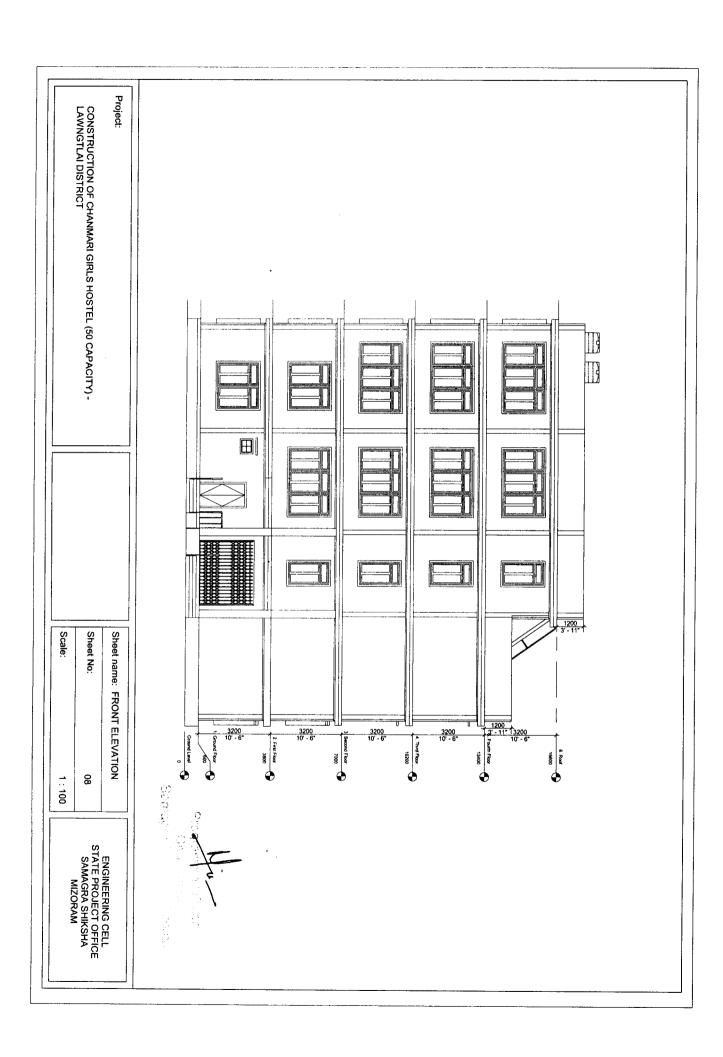

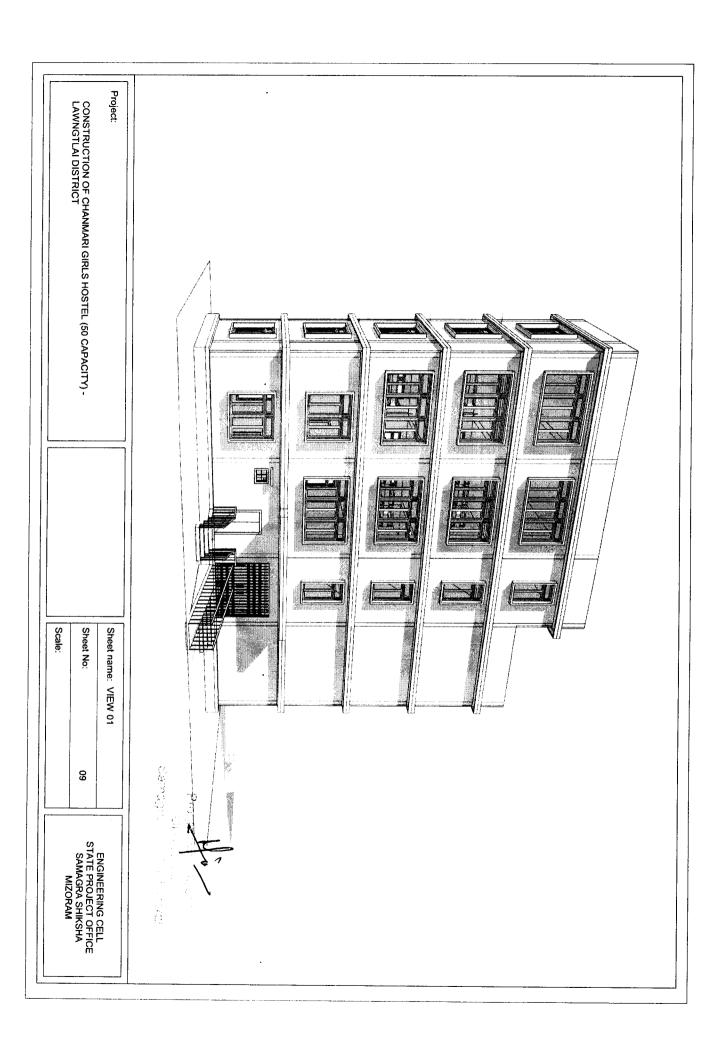



Project: CONSTRUCTION OF CHANMARI GIRLS HOSTEL (50 CAPACITY) - LAWNGTLAI DISTRICT Scale: Sheet name: VIEW 02 Sheet No: 6 ENGINEERING CELL STATE PROJECT OFFICE SAMAGRA SHIKSHA MIZORAM

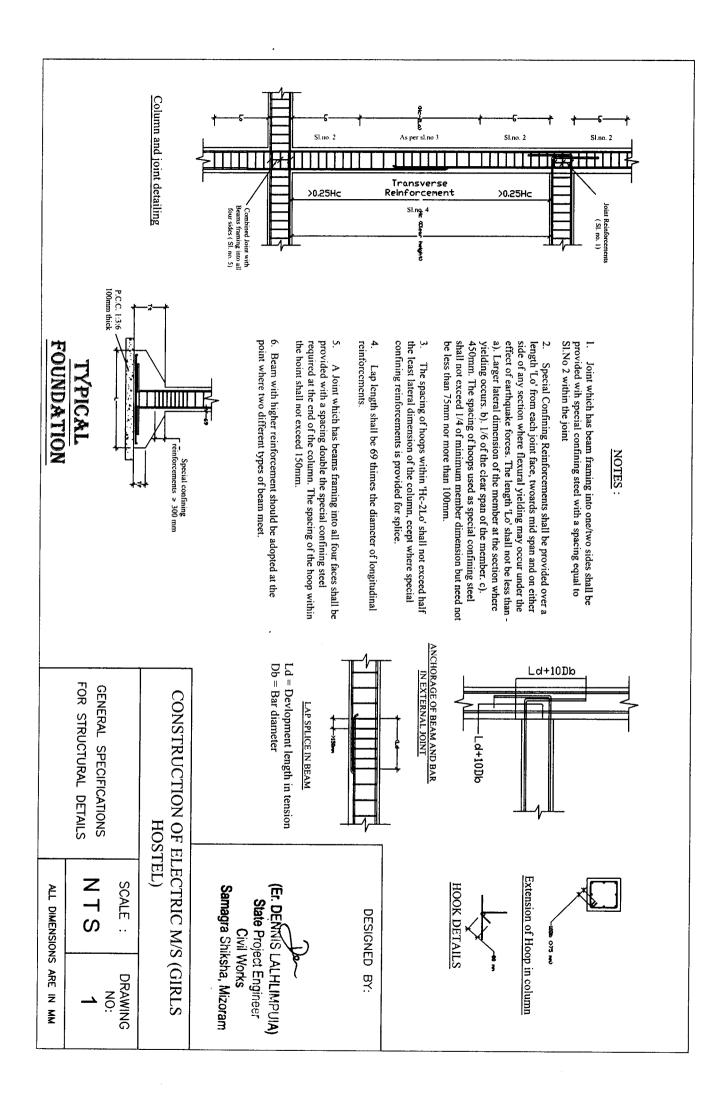

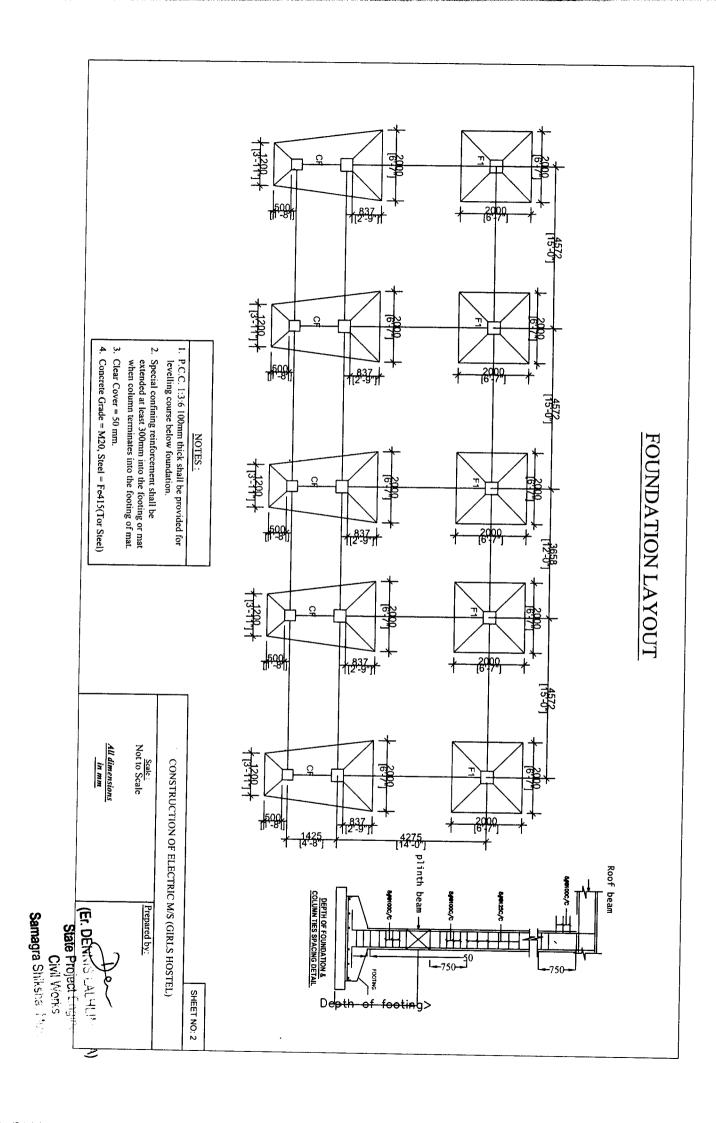

### FOUNDATION DETAILS

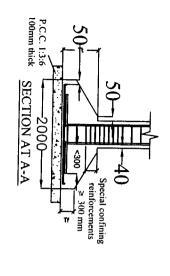

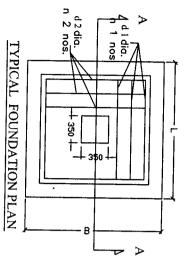


NOTES:	
--------	--


- 1. P.C.C. 1:3:6 100mm thick shall be provided for levelling course below foundation.
- 2. Special confining reinforcement shall be extended at least 300mm into the footing or mat when column terminates into the footing of mat.
- 3. Clear Cover = 50 mm.
- 4. Concrete Grade = M20, Steel = Fe415(Tor Steel)

	_		_	_	_						
	Cr	Cr.	1	7		9	Type of Footing:				
	2000 X 1200	2000 W 200	2000 X 2000	3000 V 3000	£ > 5	IvB	Dimensions :				
	150		150				T.f				
	300		300			1.	-}				
	12 mm		12 mm		d l dia.		L Dir				
	20		20		n l nos.		L Direction:				
	12 mm		12 mm	0.00	Dia do	0.00	B Direction				
i	12	21	20	11 2 1100.	n 2 nos						


SHEET NO: 3

Civil Works
Samagra Shiksha, Mizoram

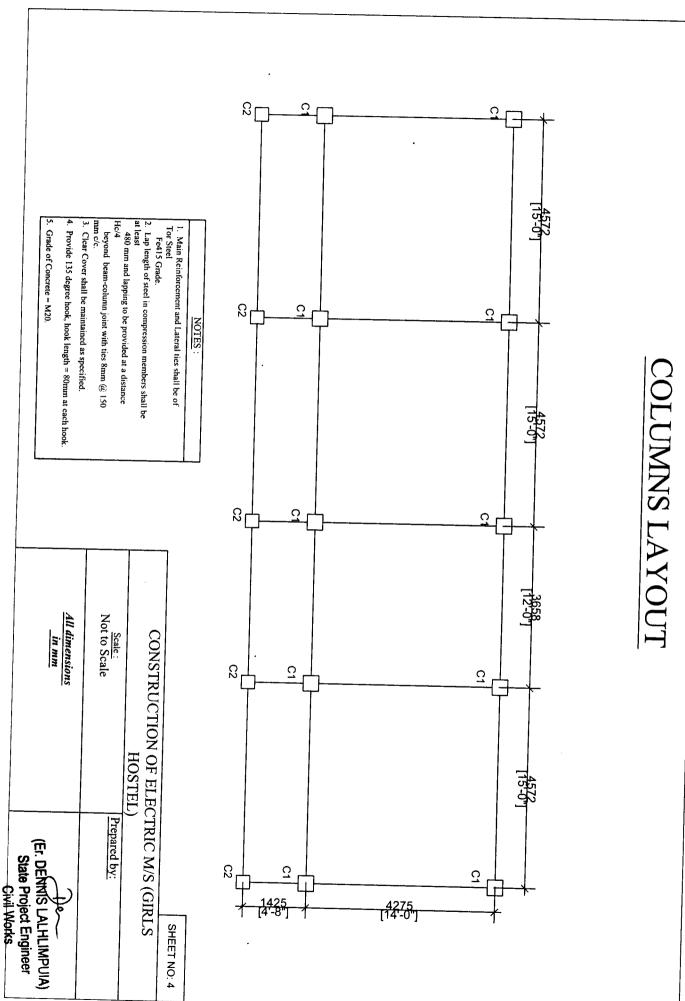

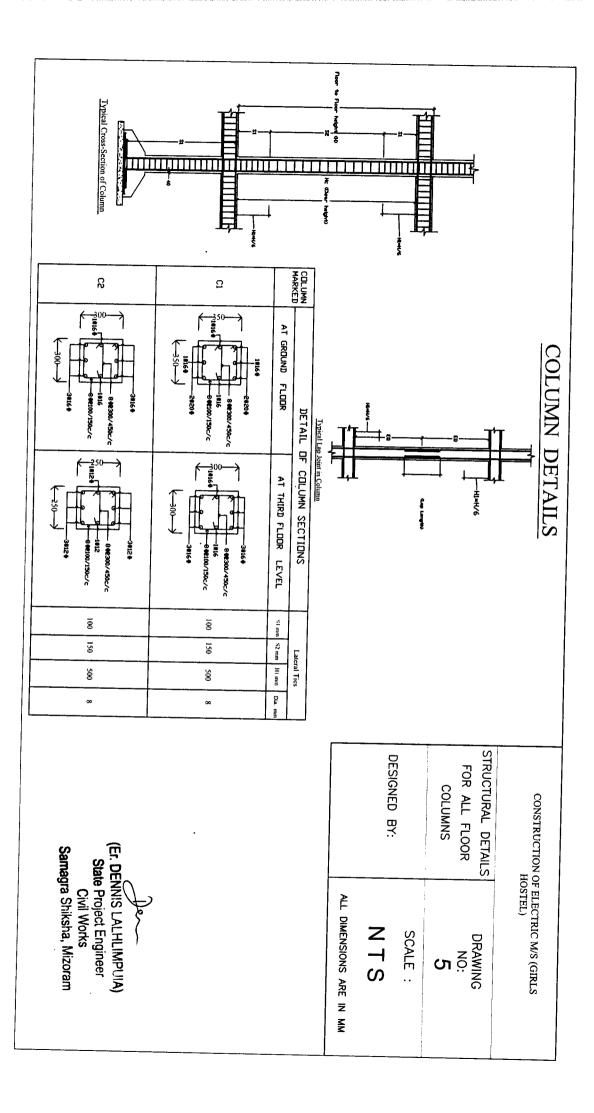


### DETAILS OF BEAM

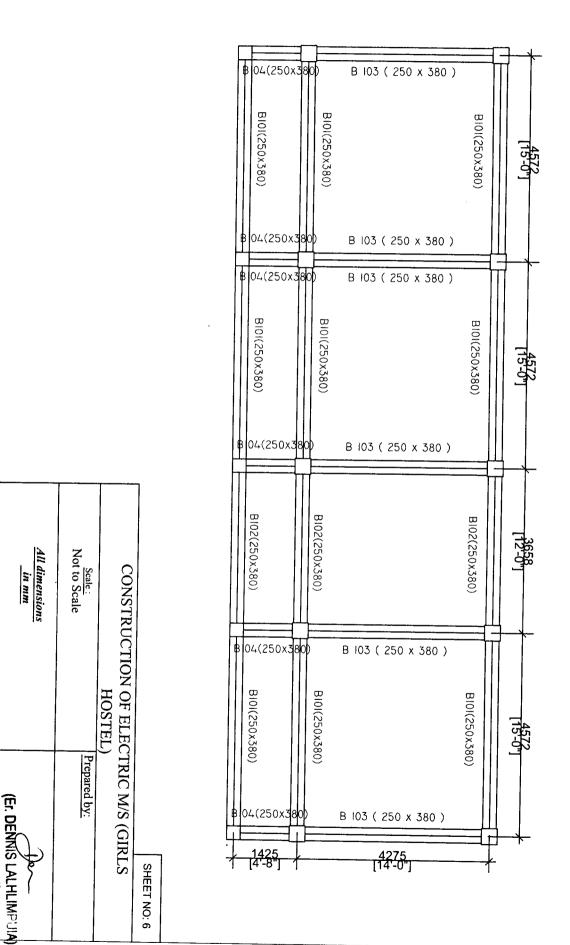

State Project Engineer
Civil Works
Samagra Shiksha, Mizoram

# TYPICAL LONG SECTION OF BEAM

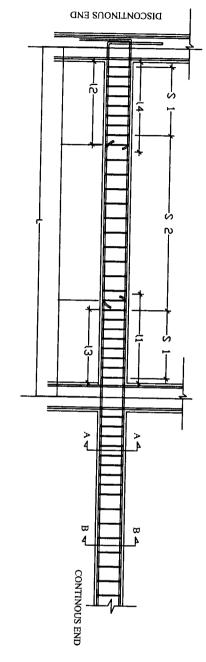



LAP SPLICE IN BEAM

Ld = Devlopment length in tension
Db = Bar diameter

#### Where,

\$1 = Spacing of stirrups for a length of 2d \$2 = Spacing of stirrups in the mid-span Ld = development length of bar in tension L = Length of beam (C/C of column)

#### Typical long section of beam

			T	Ta
B 104	B 103	B 102	B 10}	Type of Beam :
250 × 380	250 x 380	250 × 380	250 x 380	Dimensions : (mm)
3#16+	3#16 6	3#16 + 15	3#16 ¢	Section at A-A
2#16 +	2#16 #	3k0 3k0 2#16 4	2#16 6	Section at B-B
1425	4275	3658	4572	(MM)
400	1250	1100	1350	(mm)
200	650	550	650	(MW)
350	1050	000	1150	(mm)
900	850	700	900	- (mm)
Kmm dia. Tor steel. 2 kgged, 2 100 mm cic	Nmm dia. For steel. 2 legged, 4 109 inm ere	Nmm dia. For steel. 2 legged. 4 100 mm pc	Rearn dia. For steet. 2 kggod. 2 100 mm c/c	S
8mm dis. Tor steel. 2 legged. 2 150 mm c/c	8mm dia. For steel, 2 legged, 4 150 mm c/c	8mm dia. Tor steel. 1 legged. ⊋ 150 mm c/s	Smm dia. Tor steel. 2 le gged. 4 150 mm o	S 2

#### SPECIFICATIONS:

- Clear Cover for Beam = 25mm.
- Grade of Concrete = M 20 Grade of Steel = Fe 415
- 4. The first hoop shall be at a distance not exceeding 50mm from the joint face.
- Minimum Curing Period = 28 days
- adopted at the point where two different types 6. Beam with higher reinforcement should be

SHEET NO: 7

### CONSTRUCTION OF ELECTRIC M/S (GIRLS

the Aizawl Municipal Council Building regulations, 2012, have been complied with in the preparation of Certified that the requirements of Regulation 30 of this structural drawing.


Scale: Not to Scale

All dimensions in mm


(Er. DENNIS-KALHLIMPUIA)


State Project Engineer Civil Works


### DETAILS OF SLAB

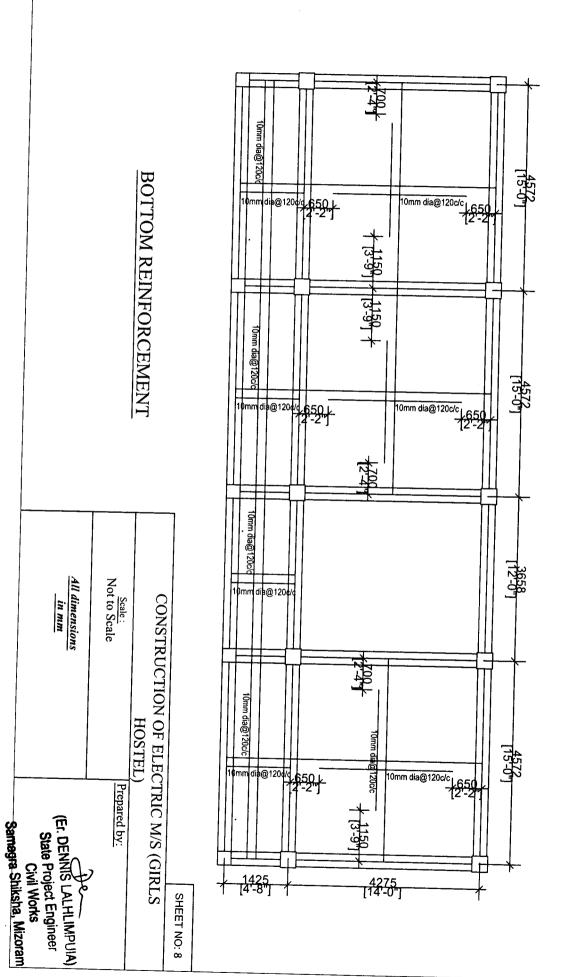

### DETAILS OF SLAB

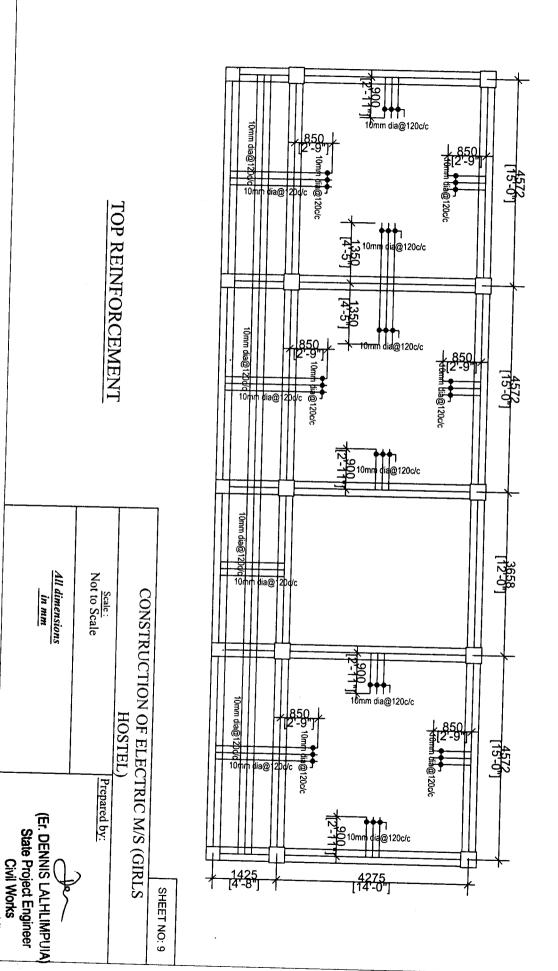

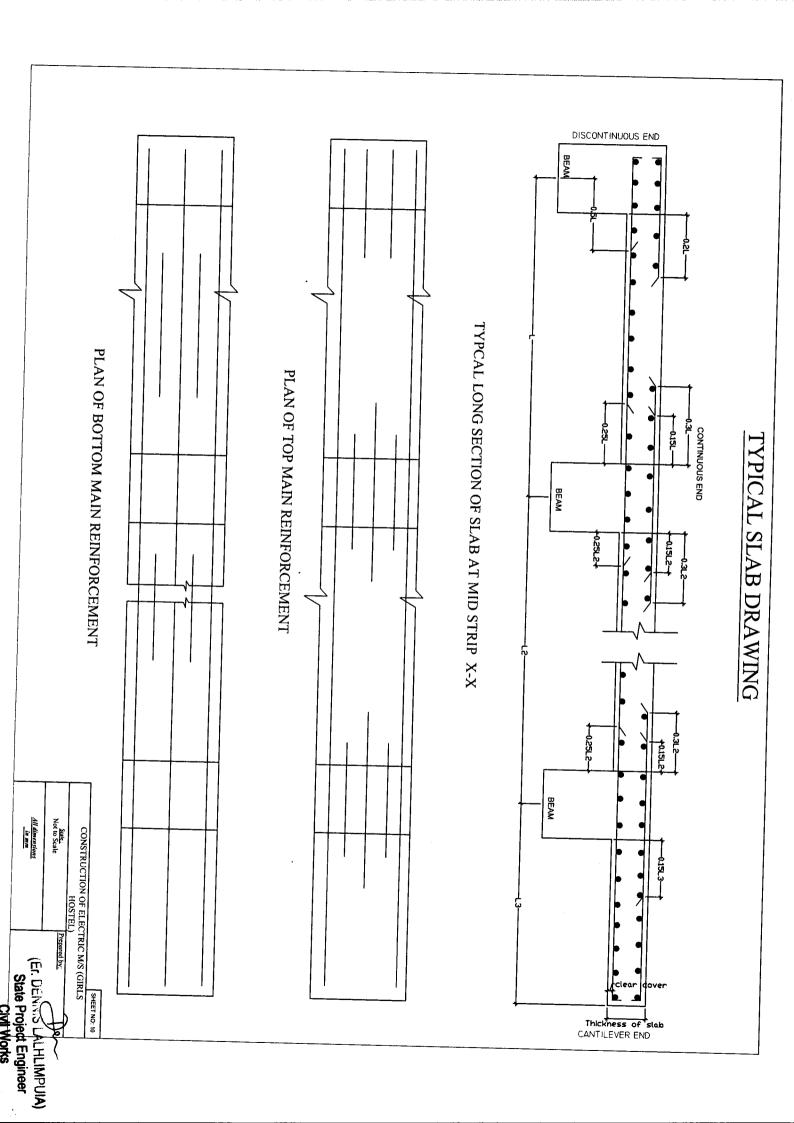

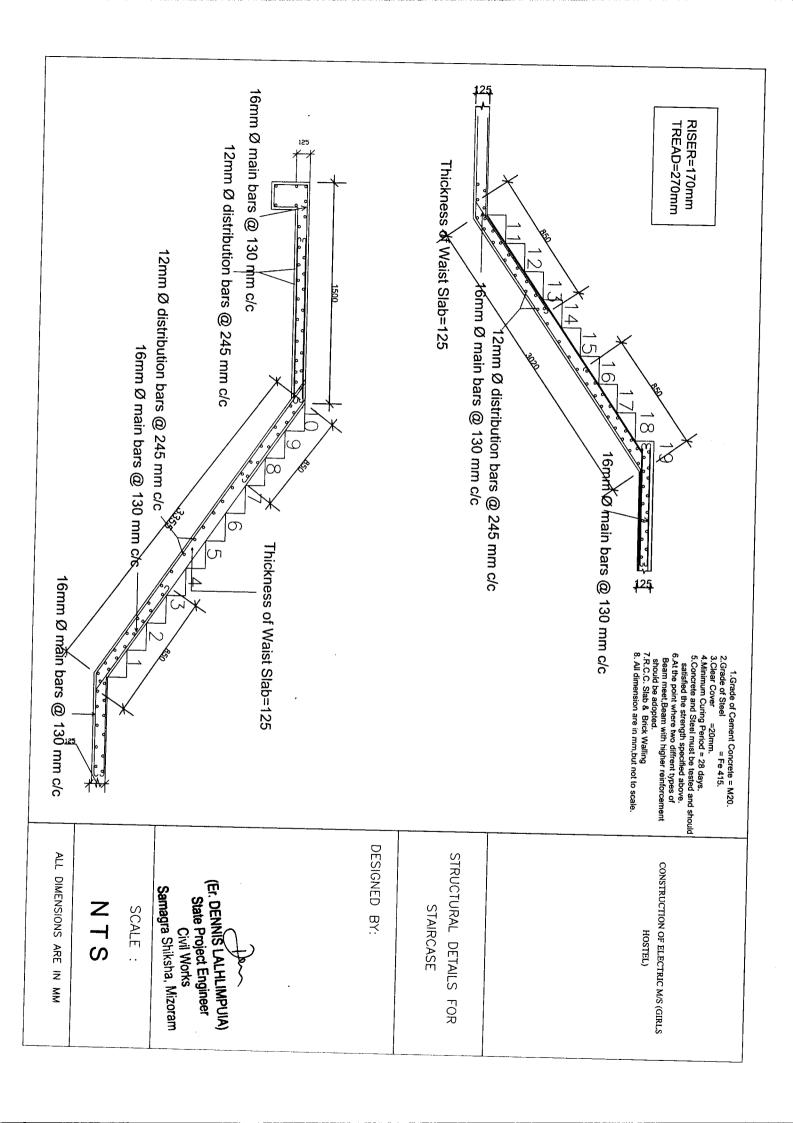

# ESTIMATE FOR CONSTRUCTION OF CHANMARI GIRLS HOSTEL, LAWNGTLAI (Electric M/S)

		18.750	cum	aggregate 20mm nominal size)	
				All work upto plinth level:	
				concrete excluding cost of centering and shuttering, finishing and reinforcement in -	5/5.01
		15.554	cum	b) 1:3:6 (1 cement : 3 coarse sand : 6 graded stone aggregate 20mm nominal size)	
				Providing and laying in position cement concrete of specified grade excluding cost of centering and shuttering All work upto plinth level:	4/4.03
		n 58.667	cum	2/3 of qty taken from 2/2.08	
				Filling available excavated earth (excluding rock) in trenches, plinth, sides of foundations etc. in layers not exceeding 20cm in depth, consolidating each deposited layer by ramming and watering, lead up to 50 m and lift upto 1.5 m.	3/2.17
		n 88.000	cum	(a) Oridinary Soil	
			<u> </u>	exceeding 2 meters depth including dressing of bottom and sides of trenches and subsequent filling and compaction in 15cm layers as in column foundations, fence posts, etc. and disposal of all surplus soil as directed within a lead of	2/2.08
		m 378.488	cum	(a) Oridinary and Hard Soil	
21 1702 183				depth, 1.5m in width as well as 10sqm on plan) including disposal of excavated earth, lead upto 50m and lift upto 1.5m, disposed earth to be levelled and neatly dressed.	1/2.06
in words Amount	in figure	nit Qty	Unit	Searchann of Items	
Rate				Description of Items	Sl.no

(Er. DENNIS LALHLIMPUIA)
State Project Engineer
Civil Works
Samagra Shiksha, Mizoram

												9/5.10		8/5.18		7/5.03		6/5.02
Suspended floors, roofs, landings, shelves and their		230x350 mm	Beams.	d) califferers, etc.		300x300 mm	350x350 mm	Column	c) posts and struts.	Columns, pillars, piers, abutments,	(a) Foundations, footings, bases of columns etc. for mass	centering and shuttering including strutting, propping, etc. and removal of form works in -	b) Thermo-Mechanically Treated Bars	cutting, bending, placing in position and binding all complete	aggregate 20mm nominal size)		a) 1:1.5:3 (1 cement : 1.5 coarse sand : 3 graded stone aggregate 20mm nominal size)	니 <u>또 함</u> 는 일 는
sqm	sqm	sqm			sqm	sqm	sqm				sqm		kg		cum		cum	,
409.20	195.300	213.900			320.000	96.000	224.000				42		29936.257		134.47		24.19	

(Er. DENNIS LALHLIMPUIA)
State Project Engineer
Civil Works

Column   C	2308.26	kg	a) GI tube 40mm @ 3.72 Kg/m	
E   Support, balconies and chajjaj, etc.   Sqm   f)   Staircases (except spiral staircase)   Sqm   Excluding landings.   Sqm   Half brick masomy with first class brick in superstructure   above plinth level upto floor V level.   a)   In cement moratar 1:3 (1 cement: 3 coarse sand)   Sqm   Providing lst class local wood dressed in frames of chaukat for doors, windows, clerestory windows fixed in position.   Providing and fixing 1st class teak wood panelled shutters for doors etc. including M.S. butt hinges with necessary   Screws, etc. complete.   a)   40 mm thick.   Sqm   Providing and fixing anodised aluminium work for doors, windows, ventilators and partitions with extruded built up standard sections of approved make conforming to IS: 733 and IS: 1285 fixing with dash fasteners of required dia and size, including necessary   filling up of gaps at junctions, at top, bottom and sides with required PVC/neoprene gaskets etc. Aluminium sections shall be smooth, rust free, straight, mitred and jointed mechanically wherever required including cleat angle, aluminium snap beading for glazing/panelling, CP brass/stainless steel screws all complete including fixing of glasses but excluding cost of glasses.   a)   Natural colour   i)   2 - track sliding windows/ventilators.   sqm   1   Supplying of glass panes at site   a)   4   4   4   4   4   4   4   4   4				16/10.1
E   Support, balconies and chajjaj, etc.   Sqm   f)   Staircases (except spiral staircase)   Sqm   Excluding landings.   Sqm   Half brick masonry with first class brick in superstructure   above plinth level upto floor V level.   a)   in cement moratar 1:3 (1 cement: 3 coarse sand)   Sqm   Providing lst class local wood dressed in frames of chaukat for doors, windows, clerestory windows fixed in position.   Providing and fixing 1st class teak wood panelled shutters of doors etc. including M.S. butt hinges with necessary   Screws, etc. complete.   Screws, etc. complete including clear and screws all providing and fixing with dash fasteners of required dia and size, including clear and jointed mechanically wherever required including clear angle, aluminium snap beading for glazing 'panelling, CP brass stainless steel screws all complete including fixing of glasses but excluding cost of glasses.   Screws all complete including fixing   Supplying of glass panes at site   Screws all complete including fixing   Supplying of glass panes at site   Screws all complete including fixing   Supplying of glass panes at site   Screws all complete including fixing   Supplying of glass panes at site   Screws all complete including the site of the screws all complete including the screws all complete including the s	3163.26	sqm		13/20.1
E   Support, balconies and chajjaj,etc.   Sqm   f)   Staircases (except spiral staircase)   Sqm   Excluding landings.   Sqm   Half brick masonry with first class brick in superstructure above plinth level upto floor V level.   a)   in cement moratar 1:3 (1 cement : 3 coarse sand)   sqm   Providing lst class local wood dressed in frames of position.   Providing and fixing lst class teak wood panelled shutters for doors, windows, clerestory windows fixed in position.   Providing and fixing anodised aluminium work for doors, windows, ventilators and partitions with extruded built up standard sections/ other sections of approved make conforming to IS : 733 and IS : 1285 fixing with dash fasteners of required dia and size, including necessary filling up of gaps at junctions, at top, bottom and sides with required PVC neoprene gaskets etc. Aluminium sections shall be smooth, rust free, straight, mitred and jointed mechanically wherever required including cleat angle, aluminium snap beading for glazing /panelling, CP brass /stainless steel screws all complete including fixing of glasses but excluding cost of glasses.   a)   Natural colour   i) 2 - track sliding windows/ventilators.   sqm   1	139.69	sqm	_ _	16/21
(e) support, balconies and chajjaj,etc. sqm f) Staircases (except spiral staircase)    excluding landings.   sqm     above plinth level upto floor V level.     a)   in cement moratar 1:3 (1 cement: 3 coarse sand)   sqm     Providing Ist class local wood dressed in frames of chaukat for doors, windows, clerestory windows fixed in position.     Providing and fixing 1st class teak wood panelled shutters for doors etc. including M.S. butt hinges with necessary screws, etc. complete.     a)   40 mm thick.     Providing and fixing anodised aluminium work for doors, windows, ventilators and partitions with extruded built up standard sections/ other sections of approved make conforming to IS: 733 and IS: 1285 fixing with dash fasteners of required dia and size, including necessary filling up of gaps at junctions, at top, bottom and sides with required PVC/ neoprene gaskets etc. Aluminium sections shall be smooth, rust free, straight, mitred and jointed mechanically wherever required including cleat angle, aluminium snap beading for glazing /panelling, CP brass /stainless steel screws all complete including fixing of glasses but excluding cost of glasses.     a)   Natural colour	139.69	sqm		14/11.0
E)   Support, balconies and chajjaj,etc.   Sqm   f)   Staircases (except spiral staircase)   excluding landings.   Sqm   Half brick masonry with first class brick in superstructure above plinth level upto floor V level.   a)   in cement moratar 1:3 (1 cement: 3 coarse sand)   Sqm   Providing Ist class local wood dressed in frames of chaukat for doors, windows, clerestory windows fixed in position.   Providing and fixing 1st class teak wood panelled shutters for doors etc. including M.S. butt hinges with necessary screws, etc. complete.   Providing and fixing anodised aluminium work for doors, windows, ventilators and partitions with extruded built up standard sections/ other sections of approved make conforming to IS: 733 and IS: 1285 fixing with dash fasteners of required dia and size, including necessary filling up of gaps at junctions, at top, bottom and sides with required PVC/ neoprene gaskets etc. Aluminium sections shall be smooth, rust free, straight, mitred and jointed mechanically wherever required including cleat angle, aluminium snap beading for glazing/panelling, CP brass /stainless steel screws all complete including fixing of glasses but excluding cost of glasses.			Natural colour     i) 2 - track sliding windows/ventilators	
c)   support, balconies and chajjaj,etc.   sqm     f)   Staircases (except spiral staircase)   excluding landings.   sqm     landing landings.   sqm     landing landings.   sqm     above plinth level upto floor V level.     a)   in cement moratar 1:3 (1 cement : 3 coarse sand )   sqm     Providing lst class local wood dressed in frames of chaukat for doors, windows, clerestory windows fixed in position.     Providing and fixing lst class teak wood panelled shutters for doors etc. including M.S. butt hinges with necessary screws, etc. complete.     a)   40 mm thick.   sqm     Providing and fixing anodised aluminium work for doors, windows, ventilators and partitions with extruded built up standard sections/ other sections of approved make conforming to IS: 733 and IS: 1285 fixing with dash fasteners of required dia and size, including necessary filling up of gaps at junctions, at top, bottom and sides with required PVC/ neoprene gaskets etc. Aluminium sections shall be smooth, rust free, straight, mitred and jointed mechanically wherever required including cleat			angle, aluminium snap beading for glazing /panelling, CP brass /stainless steel screws all complete including fixing of glasses but excluding cost of glasses.	
e) support, balconies and chajjaj,etc.  f) Staircases (except spiral staircase)  excluding landings.  Half brick masonry with first class brick in superstructure above plinth level upto floor V level.  a) in cement moratar 1:3 (1 cement : 3 coarse sand)  Providing 1st class local wood dressed in frames of chaukat for doors, windows, clerestory windows fixed in position.  Providing and fixing 1st class teak wood panelled shutters for doors etc. including M.S. butt hinges with necessary screws, etc. complete.  a) 40 mm thick.  Providing and fixing anodised aluminium work for doors, windows, ventilators and partitions with extruded built up standard sections/ other sections of approved make conforming to IS: 733 and IS: 1285 fixing with dash fasteners of required dia and size, including necessary filling up of gaps at junctions, at top, bottom and sides with required PVC/ neoprene gaskets etc. Aluminium	·		sections shall be smooth, rust free, straight, mitred and jointed mechanically wherever required including cleat	
e) support, balconies and chajjaj,etc. f) Staircases (except spiral staircase)  excluding landings.  Half brick masonry with first class brick in superstructure above plinth level upto floor V level.  a) in cement moratar 1:3 (1 cement : 3 coarse sand)  Providing 1st class local wood dressed in frames of chaukat for doors, windows, clerestory windows fixed in position.  Providing and fixing 1st class teak wood panelled shutters for doors etc. including M.S. butt hinges with necessary screws, etc. complete.  a) 40 mm thick.  Providing and fixing anodised aluminium work for doors, windows, ventilators and partitions with extruded built up standard sections/ other sections of approved make conforming to IS: 733 and IS: 1285 fixing with dash fasteners of required dia and size, including necessary				13/11.
e) support, balconies and chajjaj,etc. f) Staircases (except spiral staircase)  excluding landings.  Half brick masonry with first class brick in superstructure above plinth level upto floor V level.  a) in cement moratar 1:3 (1 cement : 3 coarse sand)  Providing lst class local wood dressed in frames of chaukat for doors, windows, clerestory windows fixed in position.  Providing and fixing 1st class teak wood panelled shutters for doors etc. including M.S. butt hinges with necessary screws, etc. complete. a) 40 mm thick.  Providing and fixing anodised aluminium work for doors, windows, ventilators and partitions with extruded built up standard sections/ other sections of approved make			fasteners of required dia and size, including necessary	
e) support, balconies and chajjaj,etc. f) Staircases (except spiral staircase)  excluding landings.  Half brick masonry with first class brick in superstructure above plinth level upto floor V level.  a) in cement moratar 1:3 (1 cement : 3 coarse sand)  Providing 1st class local wood dressed in frames of chaukat for doors, windows, clerestory windows fixed in position.  Providing and fixing 1st class teak wood panelled shutters for doors etc. including M.S. butt hinges with necessary screws, etc. complete.  a) 40 mm thick.  Providing and fixing anodised aluminium work for doors, windows ventilators and aluminium work for doors,			standard sections/ other sections of approved make	
e) support, balconies and chajjaj,etc. f) Staircases (except spiral staircase)  excluding landings.  Half brick masonry with first class brick in superstructure above plinth level upto floor V level.  a) in cement moratar 1:3 (1 cement : 3 coarse sand)  Providing 1st class local wood dressed in frames of chaukat for doors, windows, clerestory windows fixed in position.  Providing and fixing 1st class teak wood panelled shutters for doors etc. including M.S. butt hinges with necessary screws, etc. complete.  a) 40 mm thick.	15.01		Providing and fixing anodised aluminium work for doors,	
e) support, balconies and chajjaj,etc. f) Staircases (except spiral staircase)  excluding landings. Half brick masonry with first class brick in superstructure above plinth level upto floor V level.  a) in cement moratar 1:3 (1 cement : 3 coarse sand)  Providing 1st class local wood dressed in frames of chaukat for doors, windows, clerestory windows fixed in position.  Providing and fixing 1st class teak wood panelled shutters for doors etc. including M.S. butt hinges with necessary screws, etc. complete.	43.81	sam	a) 40 mm thick.	
e) support, balconies and chajjaj,etc. f) Staircases (except spiral staircase) excluding landings. Half brick masonry with first class brick in superstructure above plinth level upto floor V level. a) in cement moratar 1:3 (1 cement: 3 coarse sand) Providing 1st class local wood dressed in frames of chaukat for doors, windows, clerestory windows fixed in position.				12/9.
e) support, balconies and chajjaj,etc. f) Staircases (except spiral staircase) excluding landings. Half brick masonry with first class brick in superstructure above plinth level upto floor V level. a) in cement moratar 1:3 (1 cement: 3 coarse sand)  Providing 1st class local model for the first class and the first class local model for the first cl	1.170	cum		11/9.
e) support, balconies and chajjaj,etc. f) Staircases (except spiral staircase) excluding landings. Half brick masonry with first class brick in superstructure above plinth level upto floor V level.	840.122	sqm	9 L	
Support, balconies and chajjaj,etc.  Staircases (except spiral staircase)  excluding landings.  sqm				10/6.
Support, balconies and chajjaj,etc.  Staircases (except spiral staircase)  sqm	63.23	sqm	excluding landings.	
support, balconies and chairs; etc	645.02	sqm	$\perp$	
			- 1	

(Er. DEN )

			1,67	25/18 01	11.11	34/1		23/14.07		22/14.11	21/2			20/2	T	1	19/:	18/		17/
	<u>s</u>								100	<u> </u>	21/20.50			20/20.75			19/20.72	18/20.51		17/12.11
,	suitable locking arrangement and making necessary	mannifacture with cover and of approved brand and	d lixing	6	etc. complete	Providing and fixing M.S. handles with necessary screws	(a) 300 mm	rroviding and fixing M.S. Tower bolts (socket bolts) bright finished with necessary screws etc. complete	a) Union type	door lock with necessary screws, etc. complete.	approved brand and manufacture on wall surface:	Applying one coat of water thinnable cement primer of	Regular exterior emulsion like supercote, walmasta etc.	on new work (three or more coats) to give an even shade.	a)   General quality	Cours).	Painting with synthetic enamel paint of approved brand and manufacture in all shades on new work (two or more coats)	primer of approved brand and manufacture on wood work (hard and soft wood) & Plywood.	b)  Matt/Antiscratch	300x300mm or more (thickness to be specified by the manufacturer) of 1st quality conforming to IS: 15622 of approved make in all colours, shades, except white, ivory, grey, fume red brown, laid on 20mm thick cement mortar 1: 4 (1cement: 4 course sand) including pointing the joints with white cement and matching pigments etc. complete. as per designed colour.
				Nos	·	Nos			Nos		sqm		sqm		sqm			sqm	sqm	
_				92.00		92.00			23.00		3163.26		3163.26		78.912			78.91	534.40	

(Er. D. State Project Engineer Civil Works

			ı	
		Nos 1.00	Providing and fixing PVC nines complete with sext	33/18.25
			complete, including cutting and making good the walls and floors wherever required.	<del>*************************************</del>
				1, 1, 1, 1, 1, 1, 1, 1, 1, 1, 1, 1, 1, 1
		·		32/17 04
			low level white P V C flushing cisters including 10 litre	
			-	
		Nos 8.00		
			(a) Orissa pattern pan with integral type foot rests	
-			(Without Cistern)	
			making good the walls and floors wherever required:	
				31/17.02
				31.13
		Nos 9.00		
			⊥	
		+	Providing and fixing ventilation cowl including jointing	30/17 42
	0	Nos 17.00	$\dashv$	
				29/1/.3/
		15.00	Providing and fixing single equal SWP DVC whin it is	20/12/2
		$\dagger$		
		<del></del>	lubricant/cement solvent complete.	
		<u> </u>		28/17.35
	00	Nos 22.00	sing SWRPVC plain hend of required	
			17.34 degree ( 87.50°) including jointing with righter	27/17.34
	.00	m 100.00	a)  110mm dia.	
			lubricant/cement solvent complete.	
		<del></del>		26/17.33
	2.00	lit 8000.00	Providing and fiving a will for attraction	
			without the cost for base support.	
			connections for inlet, outlet and overflow pipes but	

State Project Engineer Civil Works

	4.	4		ω	T	T	Τ		ω	·		_		ىد		6.5	Τ	Т.	T	<del></del>		Ţ	$\top$
	41/17.29	40/17.24		39/18.51					38/17.16					37/18 09		36/18.08		33/18.0/	25/10 07		34/18.02		
a) 750x20mm size.	Providing anf fixing anodised alluminium towel rail with two anodised alluminium brackets to wooden cleats with C.P brass screws.	Providing and fixing mirror of superior glass (of approved quality) and of required shape and size with plastic moulded frame of approved make and shade with 6 mm thick hard board backing:	(b) 750 watts	approved manufacture including connections to G.I pipes etc. complete with accessories.	l)  wnite	1	4	union complete including painting of fittings and brackets, cutting and making good the walls wherever required.	waste of standard pattern, 32mm C.P. brass brans and	make with R.S. or C.I. brackets, 15mm C.P. brass pillar	Standard of Parryware/ Hindware/ Cera and equivalent	Providing and finite White	cutting and threading the pipe and making long screws etc.	Providing and fixing G.I. Union in G.I. pipe including	b) 20mm nominal bore	Providing and fixing brass stop cock of approved quality.	b) 20mm nominal bore	Providing and fixing brass bib cock of approved quality.	a) 20mm dia nominal bore	etc. (internal works- exposed on wall).	Providing and fixing G.I. pipes complete with G.I. fitting and clamps, including cutting and making good the mall	(b) 20mm dia nominal bore	Ciamps, including cutting and making good the walls etc.
Nos		Nos	each		Nos							Nos		1408	Vos		Nos		rm			rm	
190		10.00	1.00		10.000 ·				w			15.000		27.000	27,000		15.000		50.00			80.000	

lide paper holder.    Mos   1.00	. t. 100			
sqm l	12 400	m <sup>3</sup>	(a) Oridinary Soil	
Nos Nos Sam Cum sagm 1			exceeding 2 meters depth including dressing of bottom and sides of trenches and subsequent filling and compaction in 15cm layers as in column foundations, fence posts, etc. and disposal of all surplus soil as directed within a lead of 30 metres.	1/2.08 s
P. brass  P. brass  P. brass  No  n d level  R  Cum  rk  ppllying  ttural  s,  kg  e  gregate sqm  utters  flat  ils of T- plete  sqm  lete  lete,  lat  lat  gregate sqm  letes,  lat  lat  lat  gregate sqm  lat  lat  lat  gregate sqm  lat  lat  lat  lat  lat  lat  lat  la			SEPTIC TANK	
rrd size.  Nos  ner with C.P. brass  with C.P. brass  with C.P. brass  with C.P. brass  ackets.  No  ard stone in  elow ground level  fine sand)  fine sand)  cum  firamed work  sition and applying  using structural  ers, railings,  ers, railings,  kg  ers, railings,  kg  etc. complete but  ze stone aggregate  ze stone aggregate  ze stone aggregate  som	10.08	sqm	Providing and fixing in position collapsible steel shutters with vertical channels 20x10x2mm and braced with flat iron diagonals 20x5mm size with top and bottom rails of Tiron 40x40x6mm with 40mm dia. steel pulleys complete with bolts, nuts, locking arrangement, stoppers, handles, including applying a priming coat of approved steel primer.	47/10.04
rrd size.  Nos  ner with C.P. brass  with C.P. brass  with C.P. brass  ackets.  No  ard stone in  elow ground level  fine sand)  fine sand)  cum  framed work  ition and applying  using structural  ers, railings,  kg  ers, railings,  kg  etc. complete but	41 85	sam	40 mm thick with 20 mm nominal size stone aggregate	
Nos Nos Nos kg			Cement concrete flooring 1:2:4 (1 cement: 2 sand: 4 well graded stone aggregate 20mm size) finished with a floating coat neat cement including cement slurry etc. complete but excluding the cost of nosing of steps etc.	46/12.01
ass Nos ass cum	666.91	kg	b) In a grating, frames, guard bar, ladders, railings, brackets, gates & similar works.	
P. brass prass Nos Nos No No No Id level	15.00	cum	Steel work welded in built up sections/framed work including cutting, hoisting, fixing in position and applying a priming coat of approved steel primer using structural steel etc. as required.	45/10.16
rd size. Nos er with C.P. brass with C.P. brass	1.00	No	a) Glass container with C.P. lid and brackets.  Regular coursed rubble masonry with hard stone in foundation upto one storey above and below ground level including curing, etc. complete.	44/7.01
	1.00	Nos	J C L	43/17.31
			b) Plastic toilet paper holder of standard size	12/11/.50
			Providing and fiving to: 1st manne L-11	42/17.30

(Er. DENNIS LALHLIMPUIA)
State Project Engineer
Civil Works
Chiksha, Mizoram

Г	$\neg$	<u> </u>			<u> </u>		-	Т	_	Т		_	Т-				Т	Т	T	<del></del>	
								//6.08		0.00	6/6 00				010.10	5/5 18	4/20.08		3/5.10		2/5.03
						b) in cement mortar 1:4 (1 cement : 4 fine sand)	1.	Honey-comb of half brick masonry with first class brick	(b) in cement mortar 1:4 (1 cement : 4 fine sand)	including curing, etc. complete.	7.5 cm thick brick masonry with first class brickl	@ 0.62/ Rm	(b) I III CIIIIO-MCCII AIII CAI Y I FEARED BATS	(h) Thermo Machanicalli. That I D	complete	Steel reinforcement for RCC work including straightening, cutting hending placing in position and hinding all	12mm cement plaster 1:4 (1 cement: 4 fine sand).	(e) Suspended floors, roofs, landings,	Centering and shuttering including strutting, propping, etc. and removal of form works in -	aggregate 20mm nominal size)	Reinforced cement concrete work in beams, suspended floor reinforcement complete.
						m²			m²			m					m²	m²		m³	
						7.36			6.28			66.87					14.795	4.671		1.185	
GRAND TOTAL	Add GST(6%)	Add Labour Cess(1%)	Total of Civil Work inclusive of Cost Indices	Add C.I for Lawngtlai Dist.(35.51%)	TOTAL																

(Er. DENNIS LALHLIMPUIA)
State Project Engineer
Civil Works
Samagra Shiksha, Mizoram

#### **BILL OF QUANTITIES**

NAME OF WORK : INTERNAL ELECTRIFICATION OF NSCBAV (CHANMARI GIRLS HOSTEL); LAWNGTLAI DISTRICT

	C:02:02							C:02:01	C:02:00	200	ŝ
Property Carlo Ping Foint (modular)	Wiring in looping system with PVC wire sheathed standard copper conductor/wires as per IS:694 (1990) and Flame retardant low smoke & Halogen (FR-LSH) 1100 voltage graded copper flexible wire stranded copper running inside PVC casing & capping (Gr-II) 20x12mm fixed, surface on the wall/ceiling /floor as per convenience including junction box having required numbers of ways from DB to the light plug/socket 5/6A point etc. as required:	(a) Medialit Folit (Modular)	FAN POINT	(b) Long Foint (Modular)	C:02:01 (D) Long Brint (Mad:1-)	C:02:01 (C) Medium Beint (M. J. )	C.O2-01 (B) Short District Control of the Control o	(MODULAR TYPE)  Wiring in looping system with PVC wire sheathed standard copper conductor/wires as per IS:694 (1990) and Flame retardant low smoke & Halogen (FR-LSH)1100 voltage graded copper flexible wire stranded copper running inside PVC casing & capping (Gr-II) 20mm dia fixed, surface on the wall/ceiling/floor as per convenience including junction box having required numbers of ways from control switch to the light point etc as required:-	SURFACE PVC CASING &CAPPING COPPER WIRING ( GRADE-II)	DESCRIPTION OF MATERIAL	
Each		Each		Each	Each	Each				UNIT	
12		11		9	36	29				QUANTITY	
									9 11 6	in figure	
									in words	RATE	ייייין) באפופטובאו טוטואוכו
										AMOUNT	

(Er. DENNIS LALHLIMPUIA)
State Project Engineer
Civil Works
Samagra Shiksha, Mizoram

Two modules Switch Board (Modular)			fan		hox	follo	grad Sup folic	eart SUP grae Sup follc	eart SUP grac Sup follc	eard C:0 <b>SUP</b> Sup Solic folic	C:0 eard Sup Sup folic	earri C:0 earri SUP Supi folic	C:02:03 flee con provided con p
:00  :02:03 1 S two ways		WS elinpolyl auc	fan regulators e	boxes modular	/ 20413 DGISTON	Supplying and fi	grade-II Supplying and fi	earth wire  SUPPLYING ANI  Brade-II  Supplying and fi	earth wire  SUPPLYING ANI  Brade-II  Supplying and fi	earth wire C:01:06(C) 2X 6 earth wire SUPPLYING ANI grade-II Supplying and fi	C:02:06(B) 2X4 earth wire C:01:06(C) 2X 6 earth wire SUPPLYING ANI Brade-II Supplying and fi	earth wire C:02:06(B) 2X4 earth wire C:01:06(C) 2X 6 earth wire SUPPLYING ANI grade-II Supplying and fi	
S two ways		One Wodule Switch Board (Modular)	fan regulators etc. with necessary painting if necessary	tollowing sizes/modules on surface/recess including PVC/Steel boxes modular plate and pococoanicality		g and fixing of Mod	g and fixing of Moc	earth wire  SUPPLYING AND FIXING OF SWITCH BOARDS ( MODULAR TYPE grade-II  Supplying and fixing of Modular switch board grade II of the	(C) 2X 6 Sqmm copyore  Report of Mocopyore  Report	earth wire  C:01:06(C) 2X 6 Sqmm copper conductor/cable + 1 x 6 Sqmm earth wire  SUPPLYING AND FIXING OF SWITCH BOARDS ( MODULAR TY grade-II  Supplying and fixing of Modular switch board grade II of the	C:02:06(B) 2X4 Sqmm copper conductor/cable + 1x4 Sqmm carth wire C:01:06(C) 2X 6 Sqmm copper conductor/cable + 1 x 6 Sqmr arth wire  SUPPLYING AND FIXING OF SWITCH BOARDS ( MODULAR T trade-II)  Wipplying and fixing of Modular switch board grade in of the	re (B) 2X4 Sqmm coppere (C) 2X6 Sqmm coppere (C) 2X6 Sqmm coppere (C) AND FIXING OF	Wiring in looping system with PVC wire sheathed standard copper conductor/wires as per IS:694 1990) and Flame retardant low smoke & Halogen (FR-LSH) 1100 voltage graded copper flexible wire stranded copper running inside PVC casing & capping (Gr-II) 30x12mm fixed, surface on the wall/ceiling /floor as per convenience including junction box having required numbers of ways from DB to the power plug/socket 15/16A point etc. as required:  C:02:03(D)Power plug Point 15/16 A Long Point (Modular)  MAIN TO SUB-MAIN IN COPPER WIRE GRADE-II SURFACE (SINGLE PHASE TWO WIRES)  Wiring in looping system with PVC wire sheathed standard copper conductor/wires as per IS:694 (1990) and Flame retardant low smoke & Halogen (FR-LSH) 1100 voltage graded copper flexible wire stranded copper running inside PVC Casing & capping (Grade-II) of all available sizes diameter fixed, surface on the wall/ceiling/floor as per convenience including junction box having required numbers of ways from Main to Sub-Main/DB/Sub-Main/DB to SDB/SDB/Switch boards/SDB to switch boards as required:  C:02:06(B) 2X4 Sqmm copper conductor/cable + 1x2.5 Sqmm earth wire  C:01:06(C) 2X 6 Sqmm copper conductor/cable + 1x 6 Sqmm earth wire  SUPPLYING AND FIXING OF SWITCH BOARDS (MODULAR TYPE) grade-II  Supplying and fixing of Modular switch boards and the factors and the fixed supplying and fixing of Modular switch boards.
		rd (Modular)	ecessary painting	on surface/recess	Supplying and fixing of Modular switch board grade-II of the		C. SWIICH DOM	OF SWITCH BOA	OF SWITCH BOA	opper conductor,  OF SWITCH BOA	opper conductor/	pper conductor/ opper conductor, opper conductor, of SWITCH BOA	n with PVC wire sas per IS:694 18 FR-LSH) 1100 vo opper running ins n fixed, surface o uding junction bo )B to the power p oint 15/16 A Long (COPPER WIRE GI IRES) 1 with PVC wire sas per IS:694 (1) Halogen (FR-LSH) anded copper run all available sizes ing/floor as per c jired numbers of to SDB/SDB/Switt  copper conductor/ opper conductor/ opper conductor/
			g if necessary	s including PVC	oard grade-II of		ADOLINI COM	RDS ( MODULA	/cable + 1 x 6 S	/cable + 1 x 6 Sq.	/cable + 1x4 Sqi //cable + 1 x 6 S	or/cable + 1x4 Sqi /cable + 1x4 Sqi //cable + 1 x 6 Si	sheathed stand 990) and Flame oltage graded coside PVC casin on the wall/ceil ox having require plug/socket 15/100 voltage sheathed stand 1990) and Flame 11900 and Flame in mining inside PVs diameter fixed convenience in f ways from March boards/SDB or/cable + 1x2.5/100 voltage   100 voltage   1
			et, and	/Steel	the		AK IYPE	AR TYPE)	AR TYPE)	qmm AR TYPE)	mm qmm	5 Sqmm mm oqmm	dard e retardant copper ig & lling /floor red /16A point lar) ACE  dard e le l
-	N <sub>O</sub>							THE STATE OF	3	3 3	m m	T T T	
0	10							60	60	130	130	520 130 60	3 520 130
-													
-		-		-		·	1						

(Er. DEL. ALHLIMPUIA)
State Project Engineer
Civil Works

				- <u></u>						J:00:00		<u> </u>	 0:03:00			0:00:00				N:01:00			14.00.00	Z.		·		 	***	
(13/7) LED Batten fitting 1X26W Linea 4' with LED tube (Phillips/equivalent)	(1375) LED Batten fitting 1X12W Linea 2' with LED tube (Phillips/equivalent)	Sqmm copper conductor single core cable etc as required.	tubes etc, directly on ceiling/wall, including connection with 1.5	flourescent Light fittings of all types, with all accessories and	J:01:30 Installation, testing & commissioning of pre-wired	(1661) CFL Curvy 15W(SP) B22,E27 Base Havells/Equivalent	connection etc, as required	J:01:03 Supplying, fitting and fixing Batten Holder including	LIGHTING FIXTURES CEILING/WALL MOUNTED:-	<u> </u>	L	required.	 	Supplying, fitting, & fixing of 63 Amps' 6-ways Distribution Board	MCB DISTRIBUTION BOARD	0 DISTRIBUTION BOARDS	N:01:26 40 Amps' DP, MCB Isolator	N:01:01 5 to 32 Amps ,SP, MCB B- series	complete with connectic		Supplying and fixing of all types and rating MCBs, RCCBs, ELCBs	MCBs SP/SP&N/DP/TP/TP&N/FP		MCBs/RCCBs/ELCBs/MCCBs/EARTH FAULT RELAY	1:02:158 3 S + 1SOC +1R+ 1BKP	Eight modules Switch Board (Modular)	1:02:86 2 S + 1 R + 1SOC	1:02:38 1S + 1 Soc	Three modules Switch Board (Modular)	1:02:13 2 S
N <sub>o</sub>	No		Each	1		No	Each				Each						Each	Each							No		N <sub>O</sub>	8		No o
36	5	42				29	29				4						4	16						,	Ŋ		7	8		13

(Er. DENIA) (A)
(Er. DENIA) (A)
State Project Engineer
Civil Works
Civil Works

		LIGHT NING CONDUCTOR	K:01:00
		- 1	- 1
	·		
719	Metre	Carried & Capping	
_		copper conductor for loop earthing in the existing	
	-	Q:01:55 Supplying and drawing of 1.5 sqmm PVC sheathed	
	•	dia ))	
18	Metre	Including soldering etc. as required. (8 SWG Copper Wire (4mm	
		50mbelow ground level for conductor earth electrode,	
<u> </u>	Each	<del>,</del> ,	Q:01:00
		Q:01:10 Extra for using salt and coke for G.I or copper plate	
-		and salt ) complete as required.	
1		arrangment and water pipe, etc. (but without charcoal or coke	
<b></b>	Each	providing masonery enclosure with cover plate having locking	
		600mmx600mmx6mm thick including accessories and	
		Q:01:07 Earthing with Copper Earth plate	
		EARTHING AND LOOP EARTHING	
ω	Ö	RIO /Equivalent	
	:	(1828)Electric Storage Water Heater/Geyser 6 litres 2 KW Havells	•
ω		requirea.	
		good the damage, connection, testing and commissioning etc, as	
	Eacn		1:02:00
			3
		to 50 litres in the existing wall including fixing the Hook in the	
	_	J:02:02Installation of Instantaneous Electric Water Heater up	<del></del> -
		J:02:00Installation of all kind of Electrical appliances	
<u></u>	No	(Usha/Crompton/Equivalent)	
		(1845)Ceilling fan 1200mm Sweeps ISI marked 3 blades	
11	NO O	remote ISI marked (Usha/equivalent)	
		(1861)Bracket wall mounting fan 400mm sweeps Helix with	-
22		single core cable etc, as required	
-	Each	(upto 30cm) with 2X1.5 sqmm PVC insulated copper conductor	<u>.</u>
		regulator, including wiring the down rod of standard length	<del></del>
		J:01:36 Installation, testing & commissioning of ceiling fan and	<del></del>
	č	Havells/equivalent	<u></u>
	<u></u>	light luminaire for twin high Wattage Retrofit CFL	***
		(1625) Flood Light 2X65W CFL Retro 7ING 2 Polycarbonato flood	


(Er. DENNIS LALHLIMPUIA)
State Project Engineer
Civil Works

		GRAND TOTAL
		רומים דים במהסתו כבממ
		Add 1% Labour Core
	1	Add 18% GST
-		Total
		Aluminium cable lump sum
		1- Phase Service connection 25sqmm twin core
-	Each	pipe line as required in lump sum
		Supplying and fitting of Water Cooler 120 ltrs with water
 18	Metre	from earth electrode directly in ground as required.
		R:01:67Providing and laying of copper tape 32mmx6mm thick
		(DOKSUN/Equivalent) in complete
<b></b>	Each	with base plate to mount lightning Arrestor
<del></del>		lightning Arrestor 50m 3 meters long made of SS-304 material
		R:01:10Providing and fixing of Stainless steel pole for ESE
		micro second delay (DOKSUN/equivalent)
		area of 63m diameter lightning charge capacity 100 KA and 43
	Each	Duly tested and certified by CPRI Bangalore, Having coverage
		standardized according to norms UNE 21.186 AND NPC 17.102
		6.5 (DPDC 6.5) with non electric ESE(Early steamer Emission)
		R:01:08Providing and fixing of ESE type lightning Arrestor PDC

(Er. R. LA(NUNFELA)
Programme Officer
Civil works
Samagra Shiksha, Mizoram

(Er. DENNIS LALHLIMPUIA)
State Project Engineer
Civil Works
Samagra Shiksha, Mizoram

Rupees in words

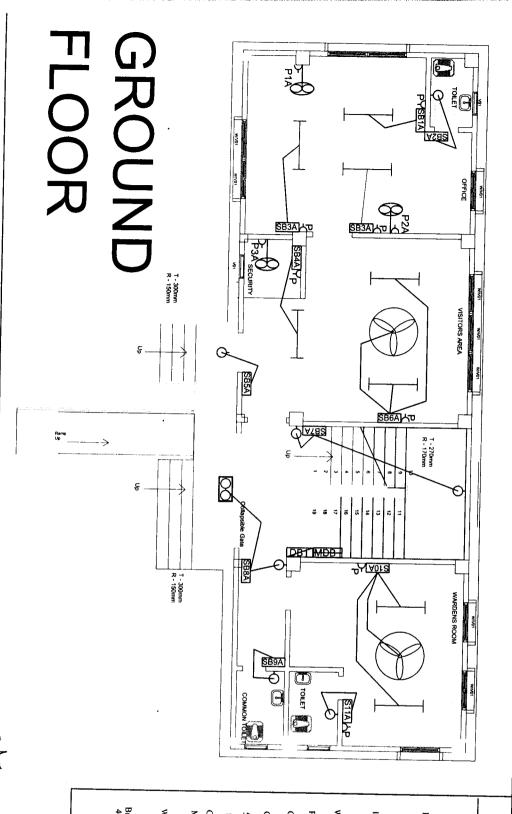

LEGENDS

SHEET NO: 1

LED Batten fitting 1 x 20W 4' with LED tube

LED Batten fitting 1 x 12W 2' with LED tube

1200mm sweep Ceiling fan

Wall mounting light(15 W CFL)

Flood light(2X65 W CFL)

Guyser 6 litres

Control Switch board(Modular)

5amp S/S comb Plug 16amp S/S comb Plug

Main Distribution Board Circuit Distribution board


Water Cooler 120 ltrs

Bracket wall mounted fan 400mm sweeps

Samagra Shiksha, Mizoran (Er. R. LÄLKUNFELA) Programme Officer

Civil works

(Er. DENNIS LALHLIMPUIA)
State Project Engineer
Civil Works

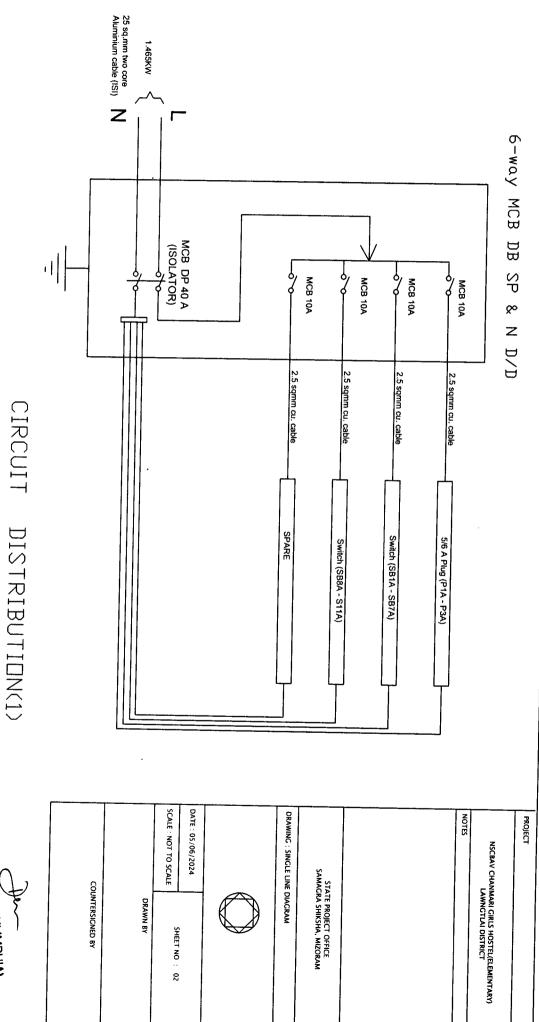


Civil works Samagra Shiksha, Mizorar

(Er. R. LÁLNUNFELA)

Programue On Jef

Civil works

(Er. DENNIS LALHLIMPUIA)
State Project Engineer
Civil Works
Samagra Shiksha, Mizoram

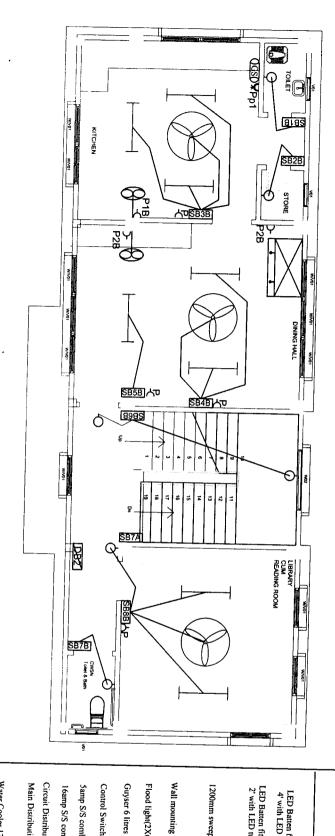

## FIRST FLOOR

**LEGENDS** 

SHEET NO: 3

LED Batten fitting 1 x 20W 4' with LED tube

LED Batten fitting 1 x 12W 2' with LED tube

1200mm sweep Ceiling fan

Wall mounting light(15 W CFL)

Flood light(2X65 W CFL)

Control Switch board(Modular)

Samp S/S comb Plug

16amp S/S comb Plug

Main Distribution Board Circuit Distribution board

Water Cooler 120 ltrs

Bracket wall mounted fan 400mm sweeps



Samagra Shiksha, Mizoram (Er. R. LALNUNFELA) Programme Officer Civil works


(Er. DENNIS LALHLIMPUIA) Samagra Shiksha, Mizoram State Project Engineer Civil Works

25 sq.mm two core
Aluminium cable (ISI) 2.155KW 6-way MCB DB MCB DP 40 A (ISOLATOR) SP MCB 10A MCB 10A MCB 10A MCB 16A œ N D/D 2.5 sqmm cu, cable 2.5 sqmm cu. cable 2.5 sqmm cu. cable Switch (SB7B & SB8B) 5/6 A Plug (P18 - P3B) 15/16 A Plug (Pp1) Switch (SB1B - SB6B) DATE: 05/06/2024 SCALE: NOT TO SCALE DRAWING: SINGLE LINE DIAGRAM NOTES PROJECT NSCBAV CHANMARI GIRLS HOSTEL(ELEMENTARY)
LAWNGTLAI DISTRICT STATE PROJECT OFFICE SAMAGRA SHIKSHA, MIZORAM COUNTERSIGNED BY DRAWN BY SHEET NO: 04

Samagra Shiksha, Mizora (Er. R. LALNUNFELA)
Programme Officer Civil works

CIRCUIT DISTRIBUTION(2)

(Er. DENNIS LALHLIMPUIA)
State Project Engineer
Civil Works

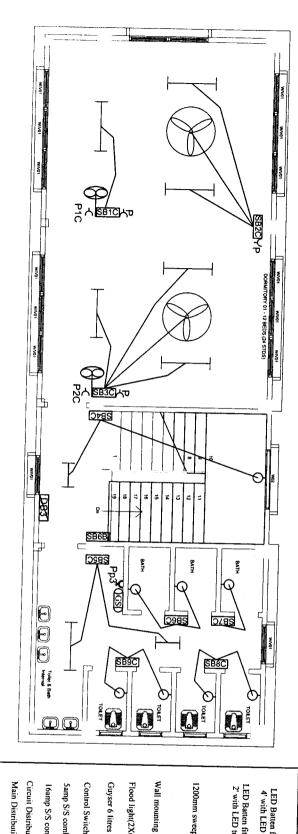

#### FLOOR SECOND

LEGENDS

LED Batten fitting 1 x 20W 4' with LED tube

LED Batten fitting 1 x 12W 2' with LED tube

1200mm sweep Ceiling fan

Wall mounting light(15 W CFL)

Flood light(2X65 W CFL)

Control Switch board(Modular)


5amp S/S comb Plug

Bracket wall mounted fan 400mm sweeps

Main Distribution Board Circuit Distribution board Water Cooler 120 ltrs 16amp S/S comb Plug


SHEET NO: 5



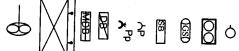

Samagra Shiksha, Mizoran (Er. R. LALKUNFELA) Programme Cittuer Civil works


(Er. DENNIS LALHLING A) Samagra Shiksha, Mizoram State Project Engineer Civil Works

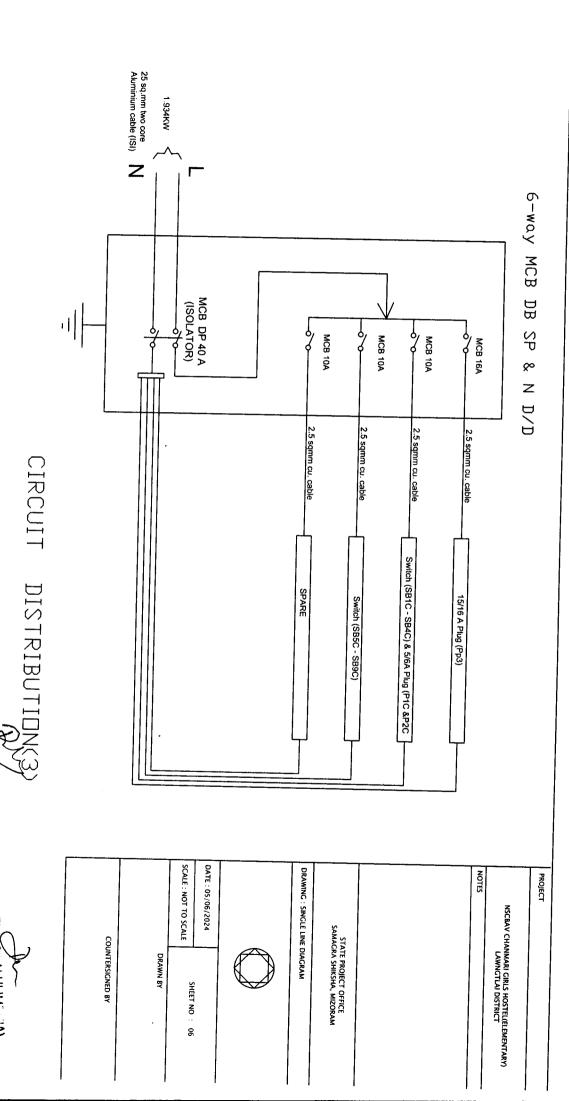

Samagra Shiksha, Mizoran

(Er. R. LALAUUNFELA)
Programme Officer
Civil works

(Er. DENNIS LALHLING TA)
State Project Engineer
Civil Works

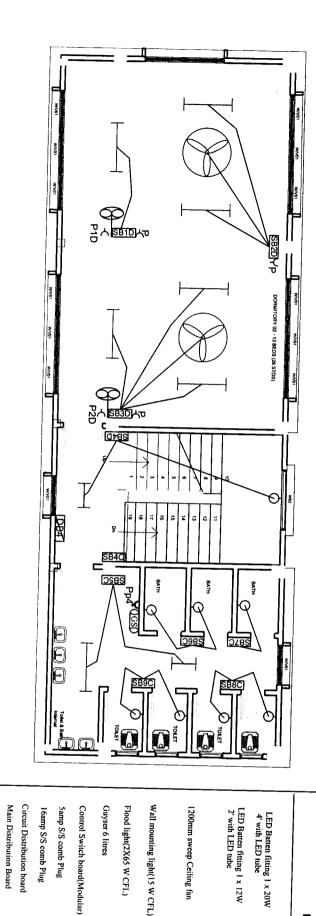

LEGENDS

SHEET NO: 7

# THIRD FLOOR




Bracket wall mounted fan 400mm sweeps

Water Cooler 120 ltrs

Programme Officer

Samagra Shiksha, Mizoran (Er. DENNIS LALHLIMPUIA) State Project Engineer Civil Works

Samagra Shiksha, Mizoram

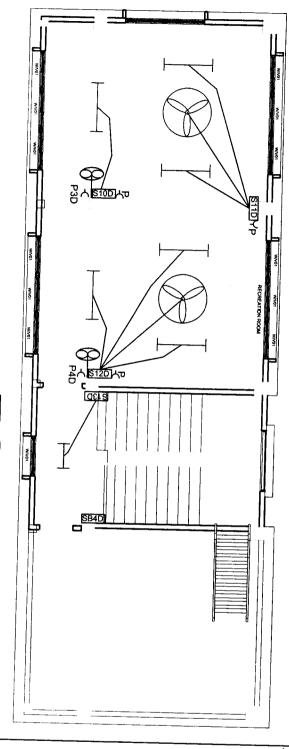

#### FOURTH FLOOR

LED Batten fitting 1 x 12W
2' with LED tube

1200mm sweep Ceiling fan

1200mm sweep Ceiling fan

Wall mounting light(15 W CFL)

Flood light(2X65 W CFL)

Guyser 6 litres

Control Switch board(Modular)

Samp S/S comb Plug

16amp S/S comb Plug

Circuit Distribution board

Main Distribution Board

Main Distribution Board

Water Cooler 120 ltrs

Bracket wall mounted fan

400mm sweeps

LED Batten fitting 1 x 20W 4' with LED tube

LEGENDS

SHEET NO: 8

(Er. R. LALINUMEELA)


(Er. R. LALINUMEELA)

Programme Officer

Civil works

Samagra Shiksha, Mizoran

(Er. DENNIS LALHLIMPUIA)
State Project Engineer
Civil Works
Samagra Shiksha, Mizoram

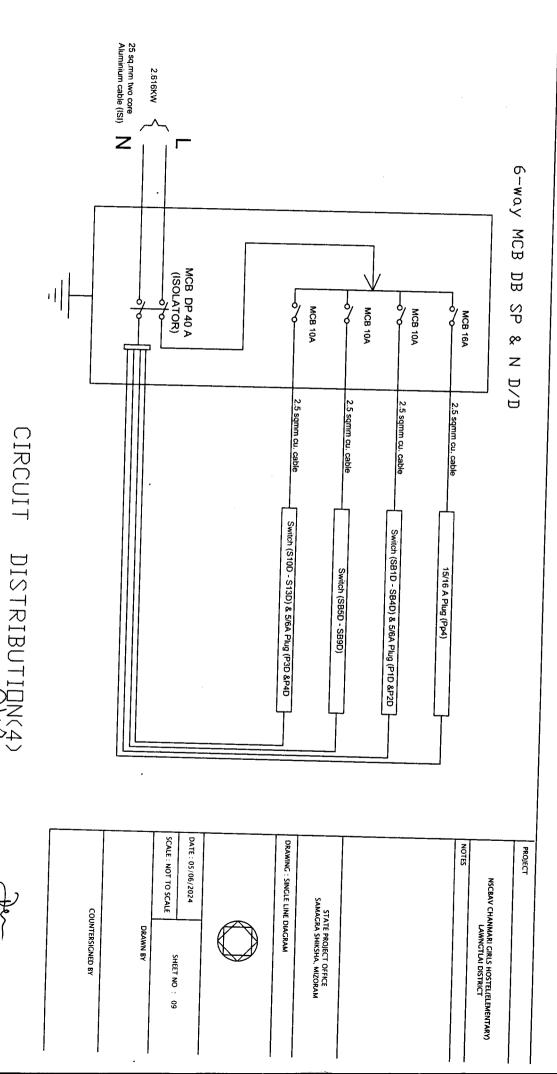

Samagra Shiksha, Mizoran

(Er. R. LALNUNFELA)
Programme Officer
Civil works

(Er. DENNIS LALHLIMPUIA)
State Project Engineer
Civil Works